DAVE & BUSTER'S - MAYFAIRE

CONSTRUCTION DOCUMENTS

WILMINGTON, NC

DATE: 1/29/2024

SHEET INDEX

C0-00 COVER SHEET


C0-01 MAYFAIRE MASTER PLAN C0-02 PLAT C1-00 DEMOLITION PLAN C2-00 EROSION CONTROL PHASE I C2-01 EROSION CONTROL PHASE II C2-02 EROSION CONTROL DETAILS

C3-00 SITE PLAN C3-01 SITE DETAILS C3-02 SITE DETAILS C3-03 SITE DETAILS C3-04 TURNING MOVEMENTS C4-00 OVERALL GRADING PLAN C4-01 DETAILED GRADING PLAN C4-02 DETAILED GRADING PLAN C4-03 DETAILED GRADING PLAN C5-00 OVERALL WATERSHED PLAN

C5-02 STORM DRAINAGE DETAILS C6-00 OVERALL UTILITY PLAN C6-01 UTILITY DETAILS C7-00 OVERALL PLANTING PLAN C7-01 PLANTING DETAILS

C5-01 STORM DRAINAGE PLAN

VICINITY MAP

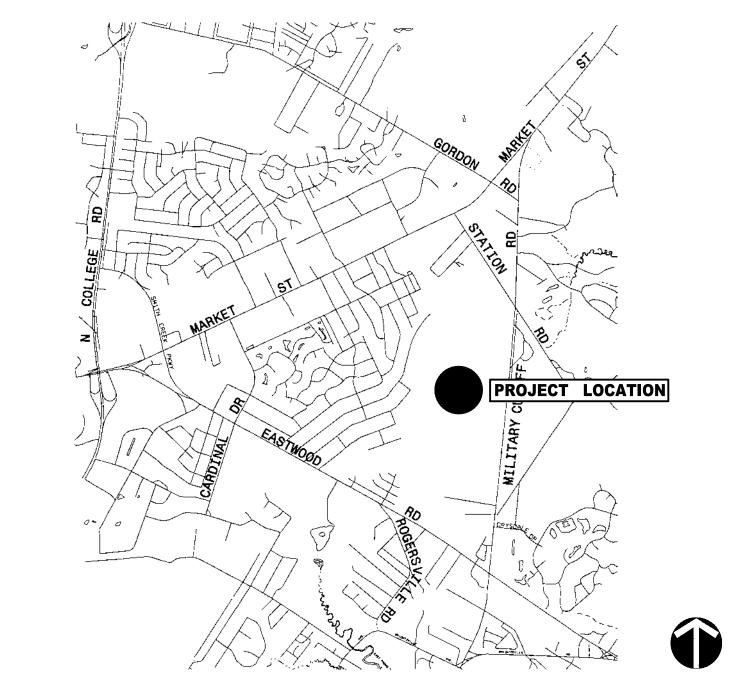

PROJECT TEAM

OWNER

CBL PROPERTIES / MAYFAIRE TOWN CENTER LP 2030 HAMILTON PLACE BLVD., SUITE 500 CHATTANOOGA, TN 37421

LANDSCAPE ARCHITECT


LANDDESIGN 223 NORTH GRAHAM STREET CHARLOTTE, NC 28202 704.333.0325 CONTACT NAME: M. RHETT CROCKER, PLA

CIVIL ENGINEER

LANDDESIGN 223 NORTH GRAHAM STREET CHARLOTTE, NC 28202 704.333.0325 CONTACT NAME: ALYSSA M. MONIACI, PE


> DAVE & BUSTER'S - MAYFAIRE 1023073

> > **COVER SHEET**

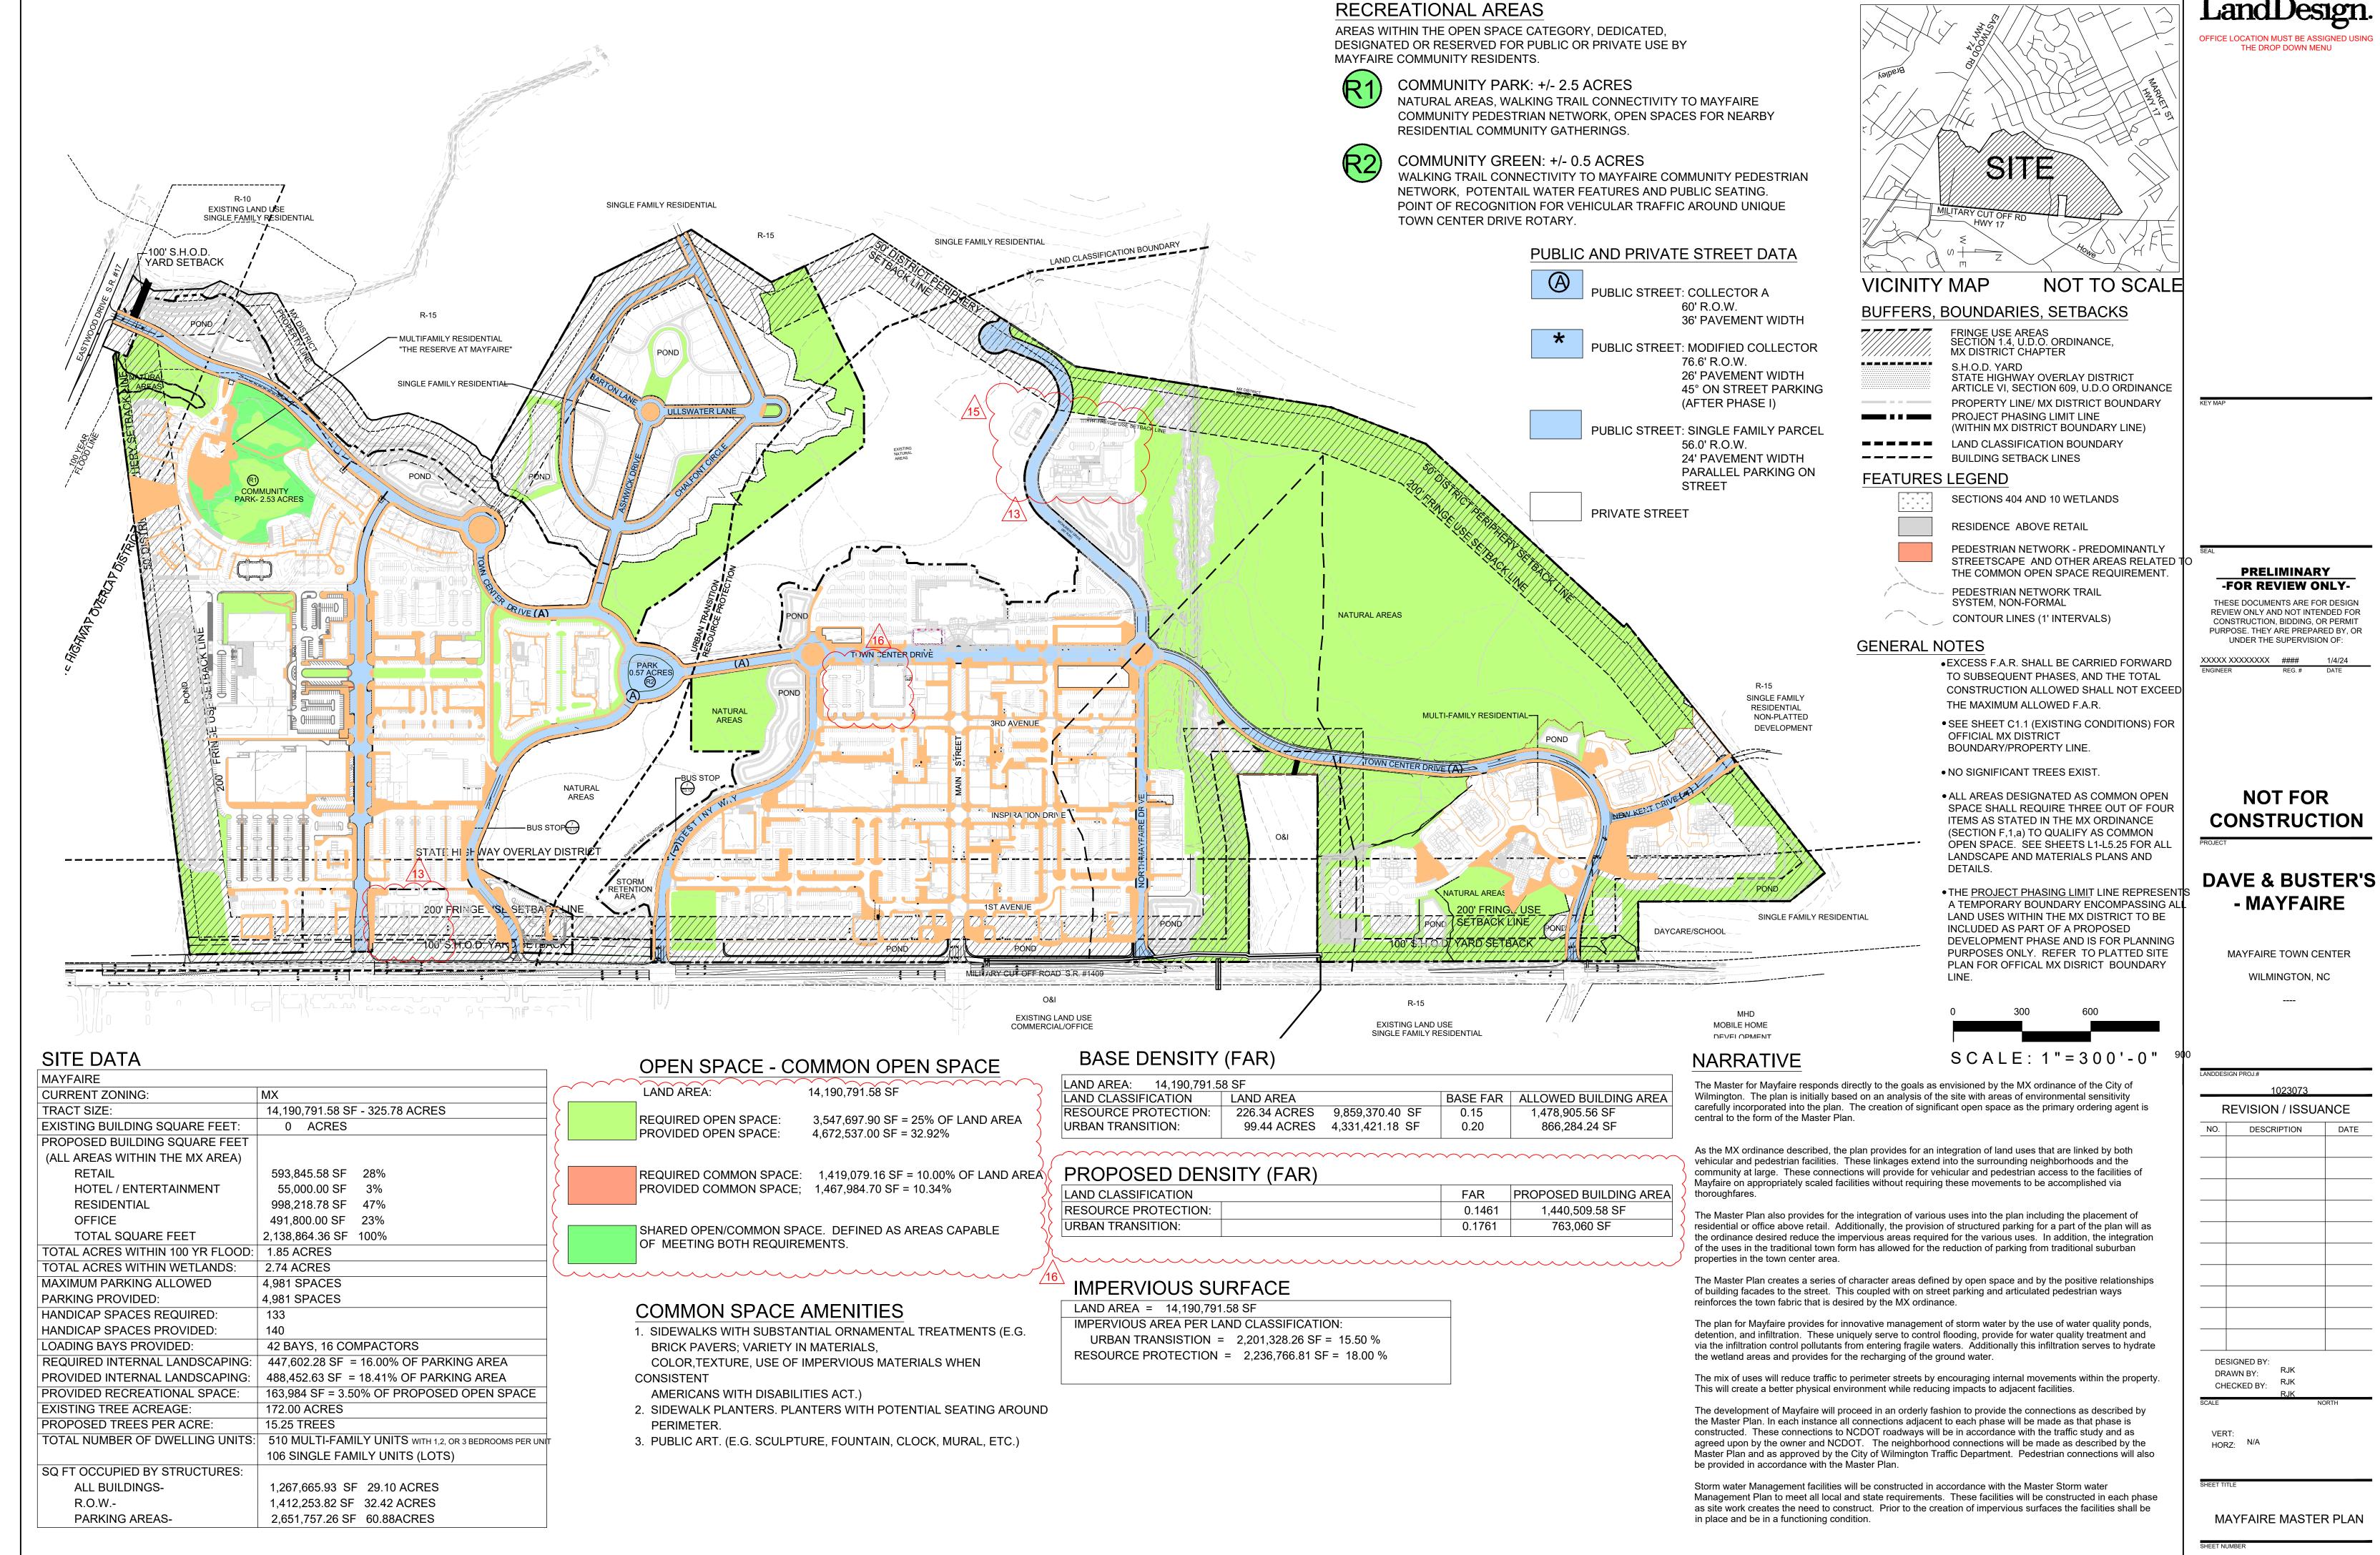

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C0-01

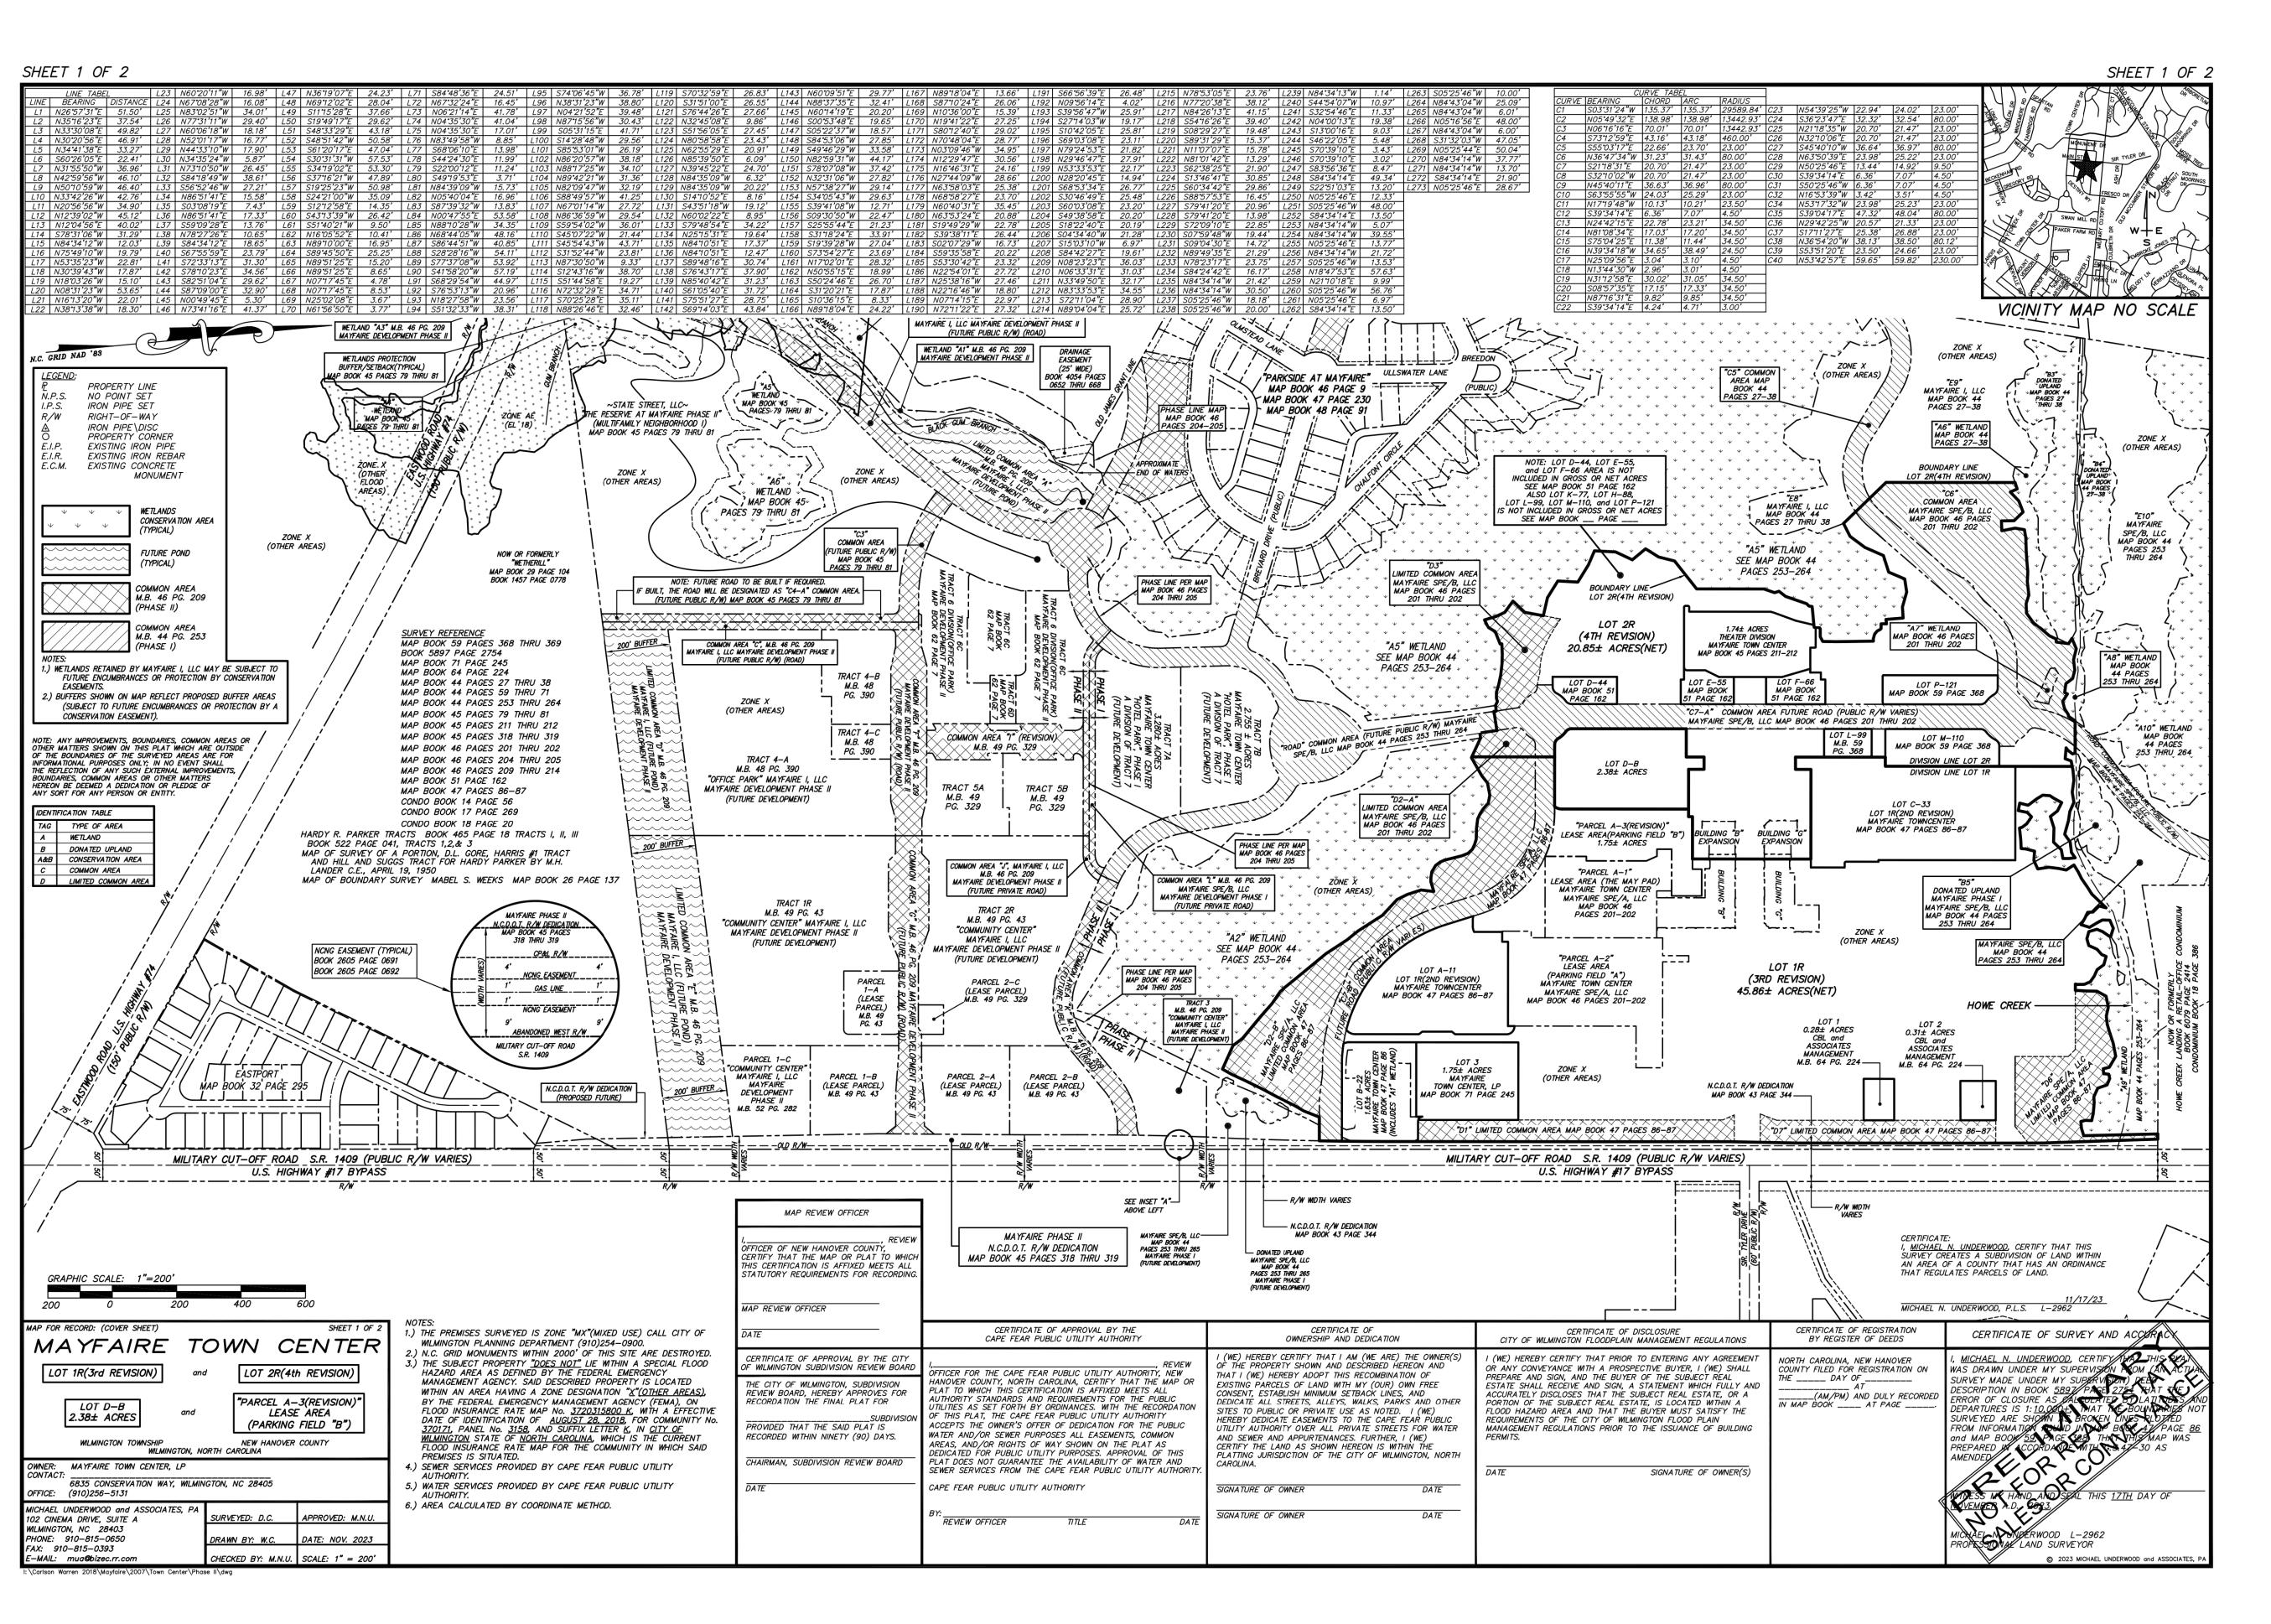

LandDesign.
223 NORTH GRAHAM STREET

CHARLOTTE, NC 28202 704.333.0325 WWW.LANDDESIGN.COM

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Alyssa M. Moniaci 046144 1/29/2024

ENGINEER REG. # DATE

DAVE & BUSTER'S - MAYFAIRE

MAYFAIRE TOWN CENTER


WILMINGTON, NC

DESIGNED BY: RJK
DRAWN BY: RJK
CHECKED BY: RJK
VERT: N/A

PLAT

HORZ: N/A

C0-02

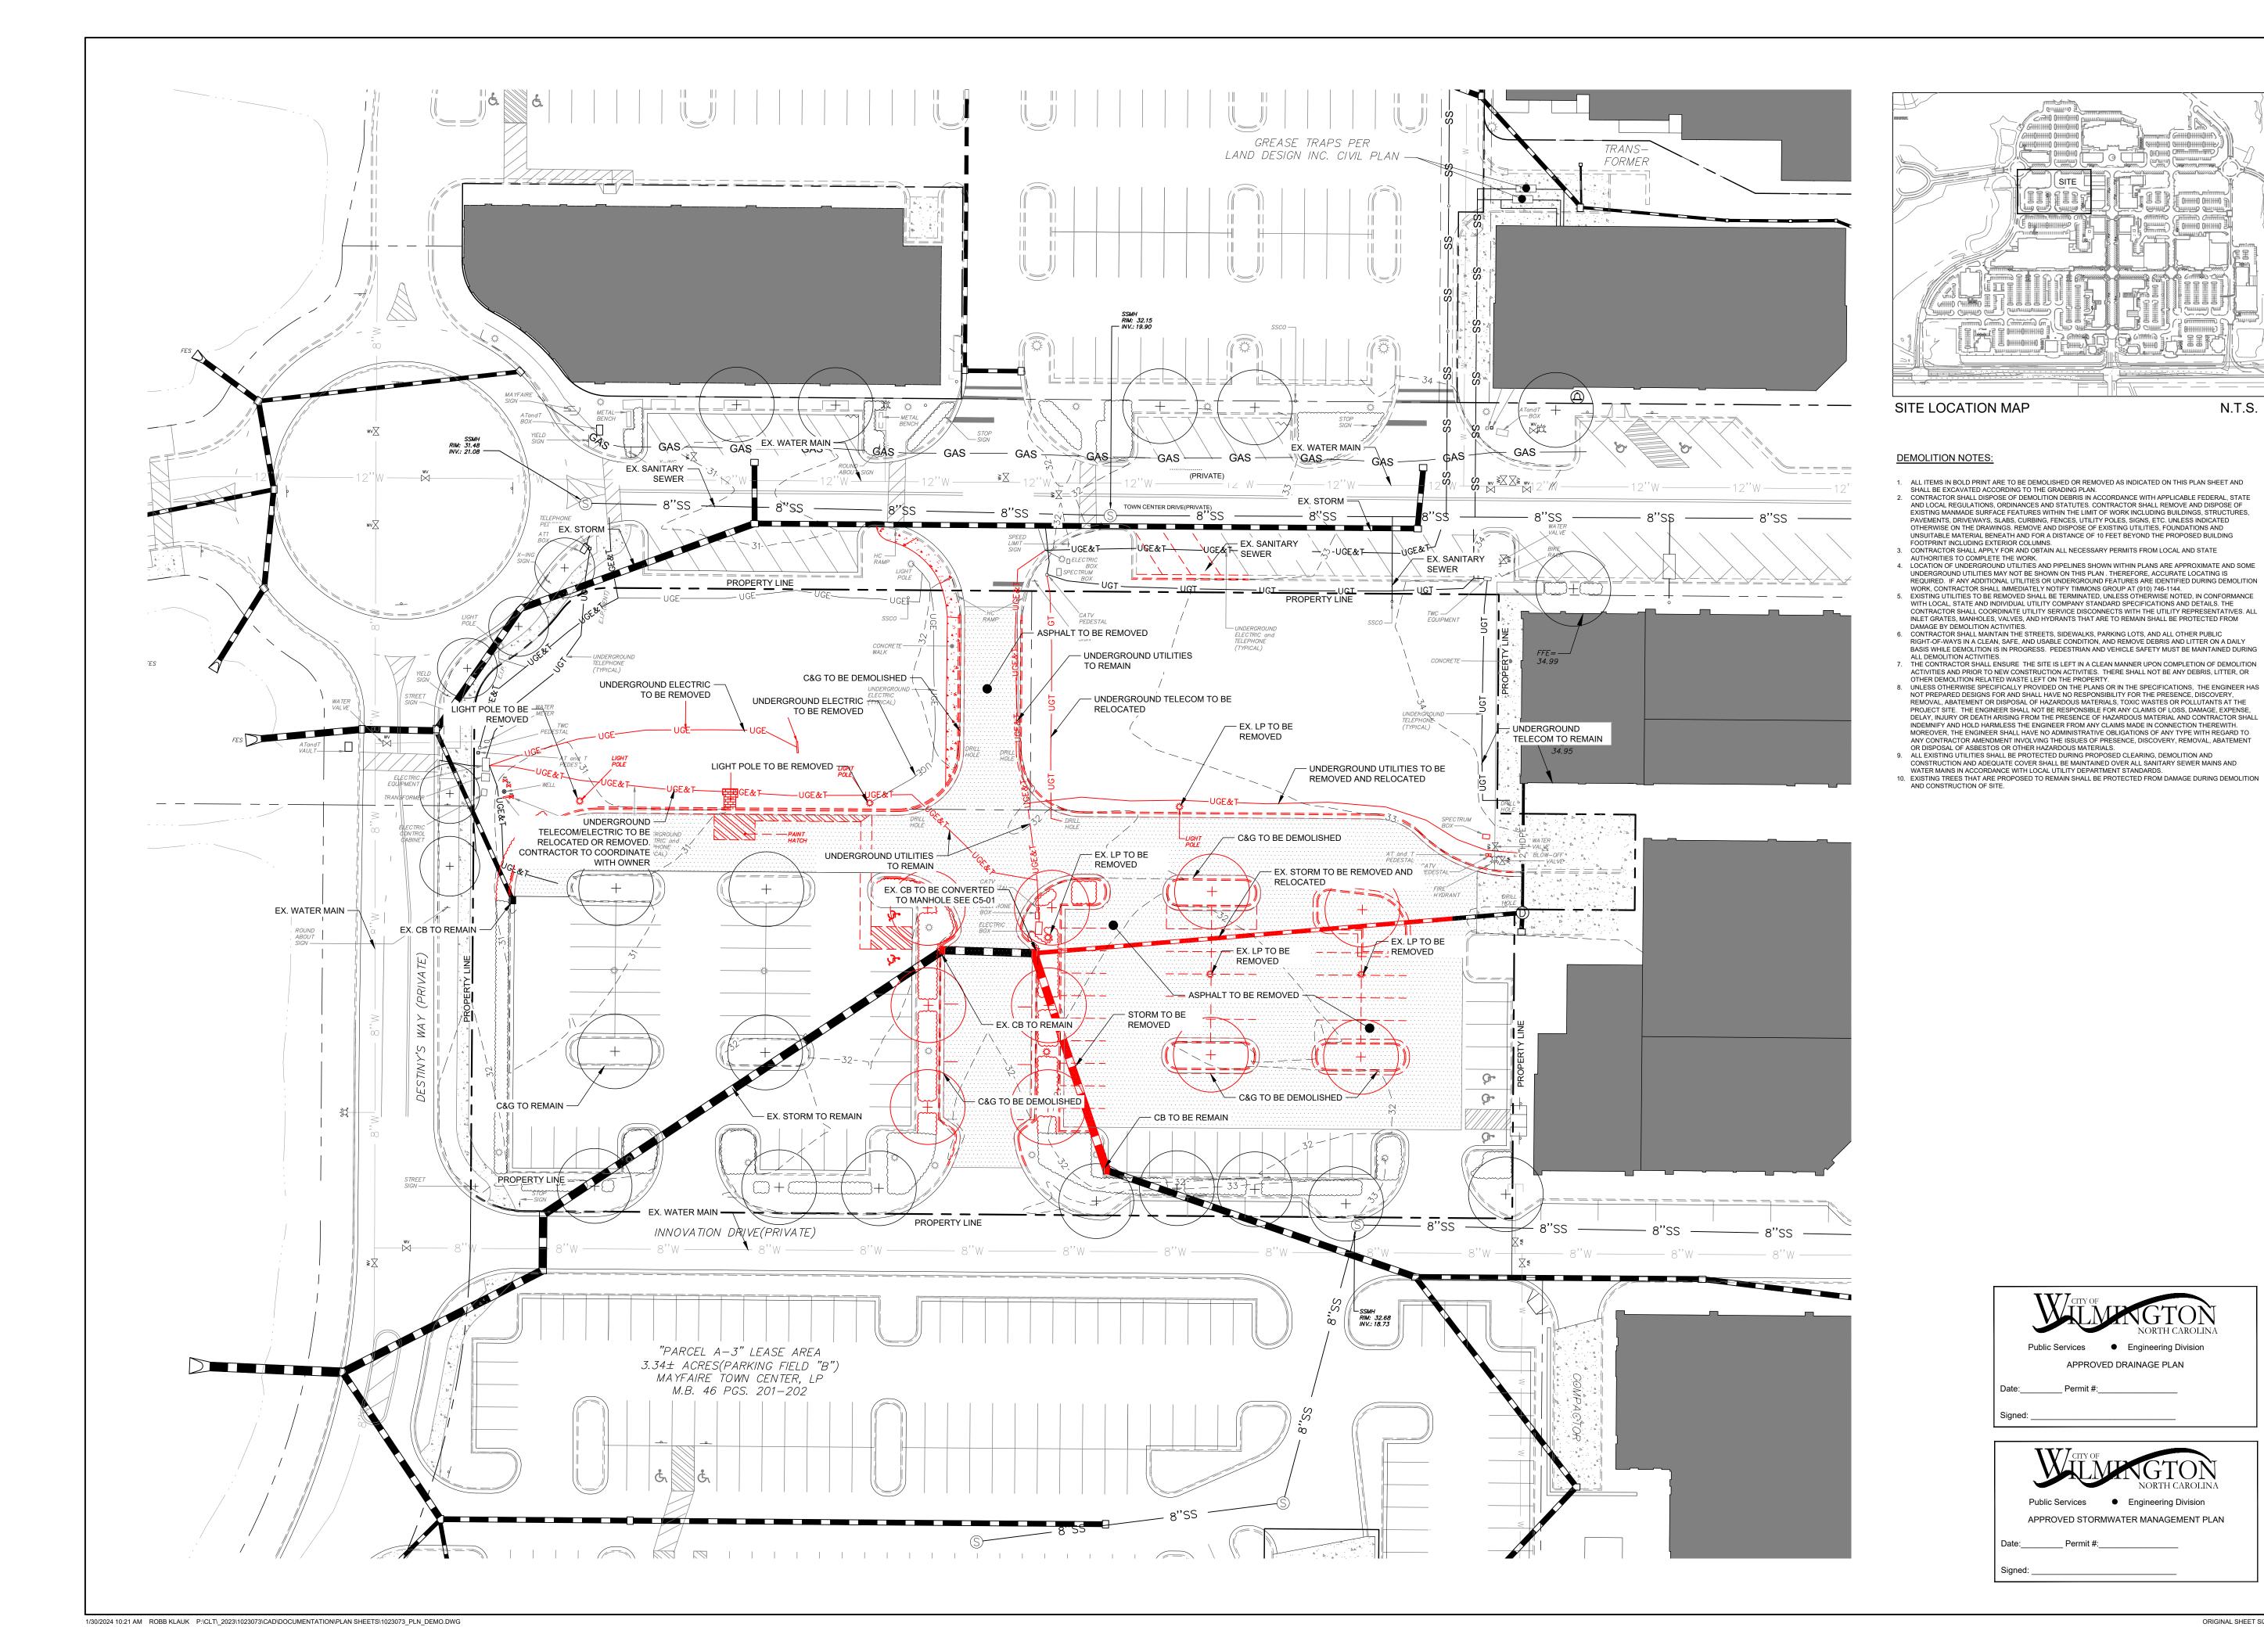

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DAVE & BUSTER'S - MAYFAIRE

MAYFAIRE TOWN CENTER

WILMINGTON, NC

1023073 REVISION / ISSUANCE

NO. DESCRIPTION DATE

DESIGNED BY: RJK DRAWN BY: RJK CHECKED BY: RJK

ORIGINAL SHEET SIZE: 22" X 34"


Public Services • Engineering Division

APPROVED DRAINAGE PLAN

APPROVED STORMWATER MANAGEMENT PLAN

DEMOLITION PLAN

C1-00

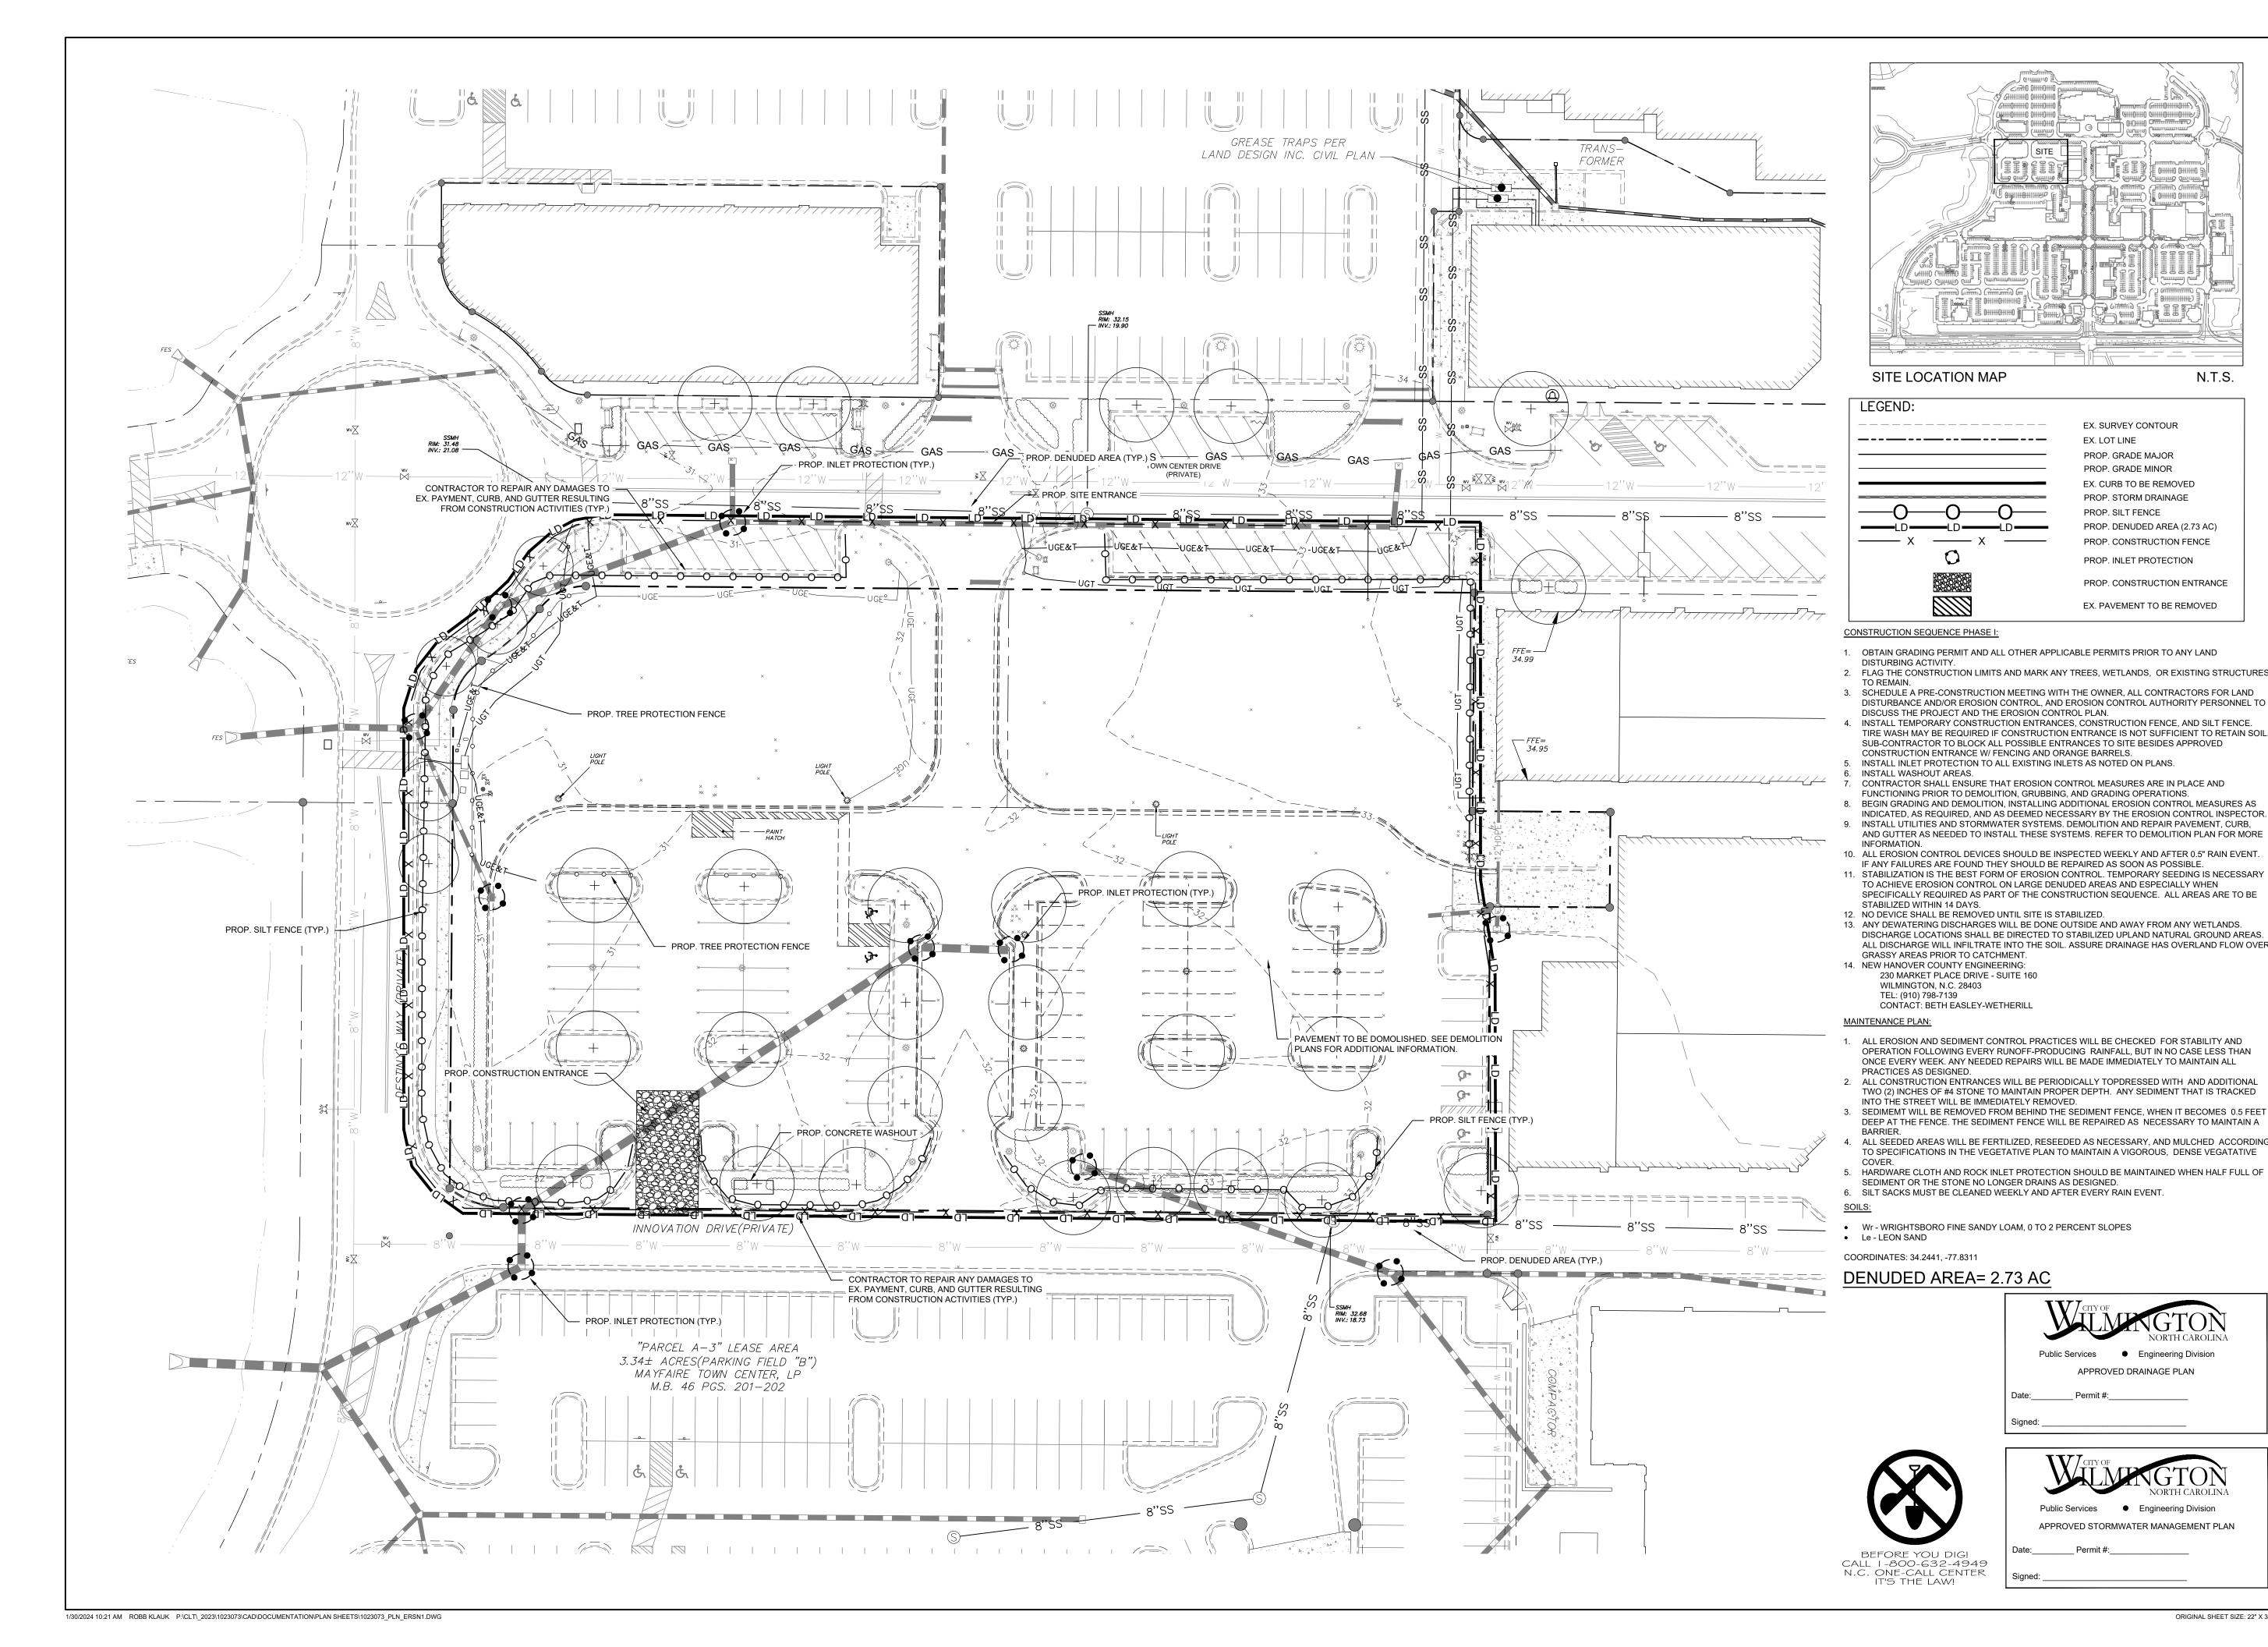



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18871 -----

EX. SURVEY CONTOUR

PROP. GRADE MAJOR

PROP. GRADE MINOR

PROP. SILT FENCE

Public Services • Engineering Division

Public Services • Engineering Division APPROVED STORMWATER MANAGEMENT PLAN

ORIGINAL SHEET SIZE: 22" X 34"

APPROVED DRAINAGE PLAN

EX. CURB TO BE REMOVED

PROP. STORM DRAINAGE

PROP. INLET PROTECTION

PROP. DENUDED AREA (2.73 AC) PROP. CONSTRUCTION FENCE

PROP. CONSTRUCTION ENTRANCE

EX. PAVEMENT TO BE REMOVED

EX. LOT LINE

N.T.S.

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DAVE & BUSTER'S - MAYFAIRE

MAYFAIRE TOWN CENTER

WILMINGTON, NC

1023073


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NO.	DESCRIPTION	DATE	

DESIGNED BY: RJK DRAWN BY: RJK

CHECKED BY: RJK

EROSION CONTROL PHASE I

C2-00

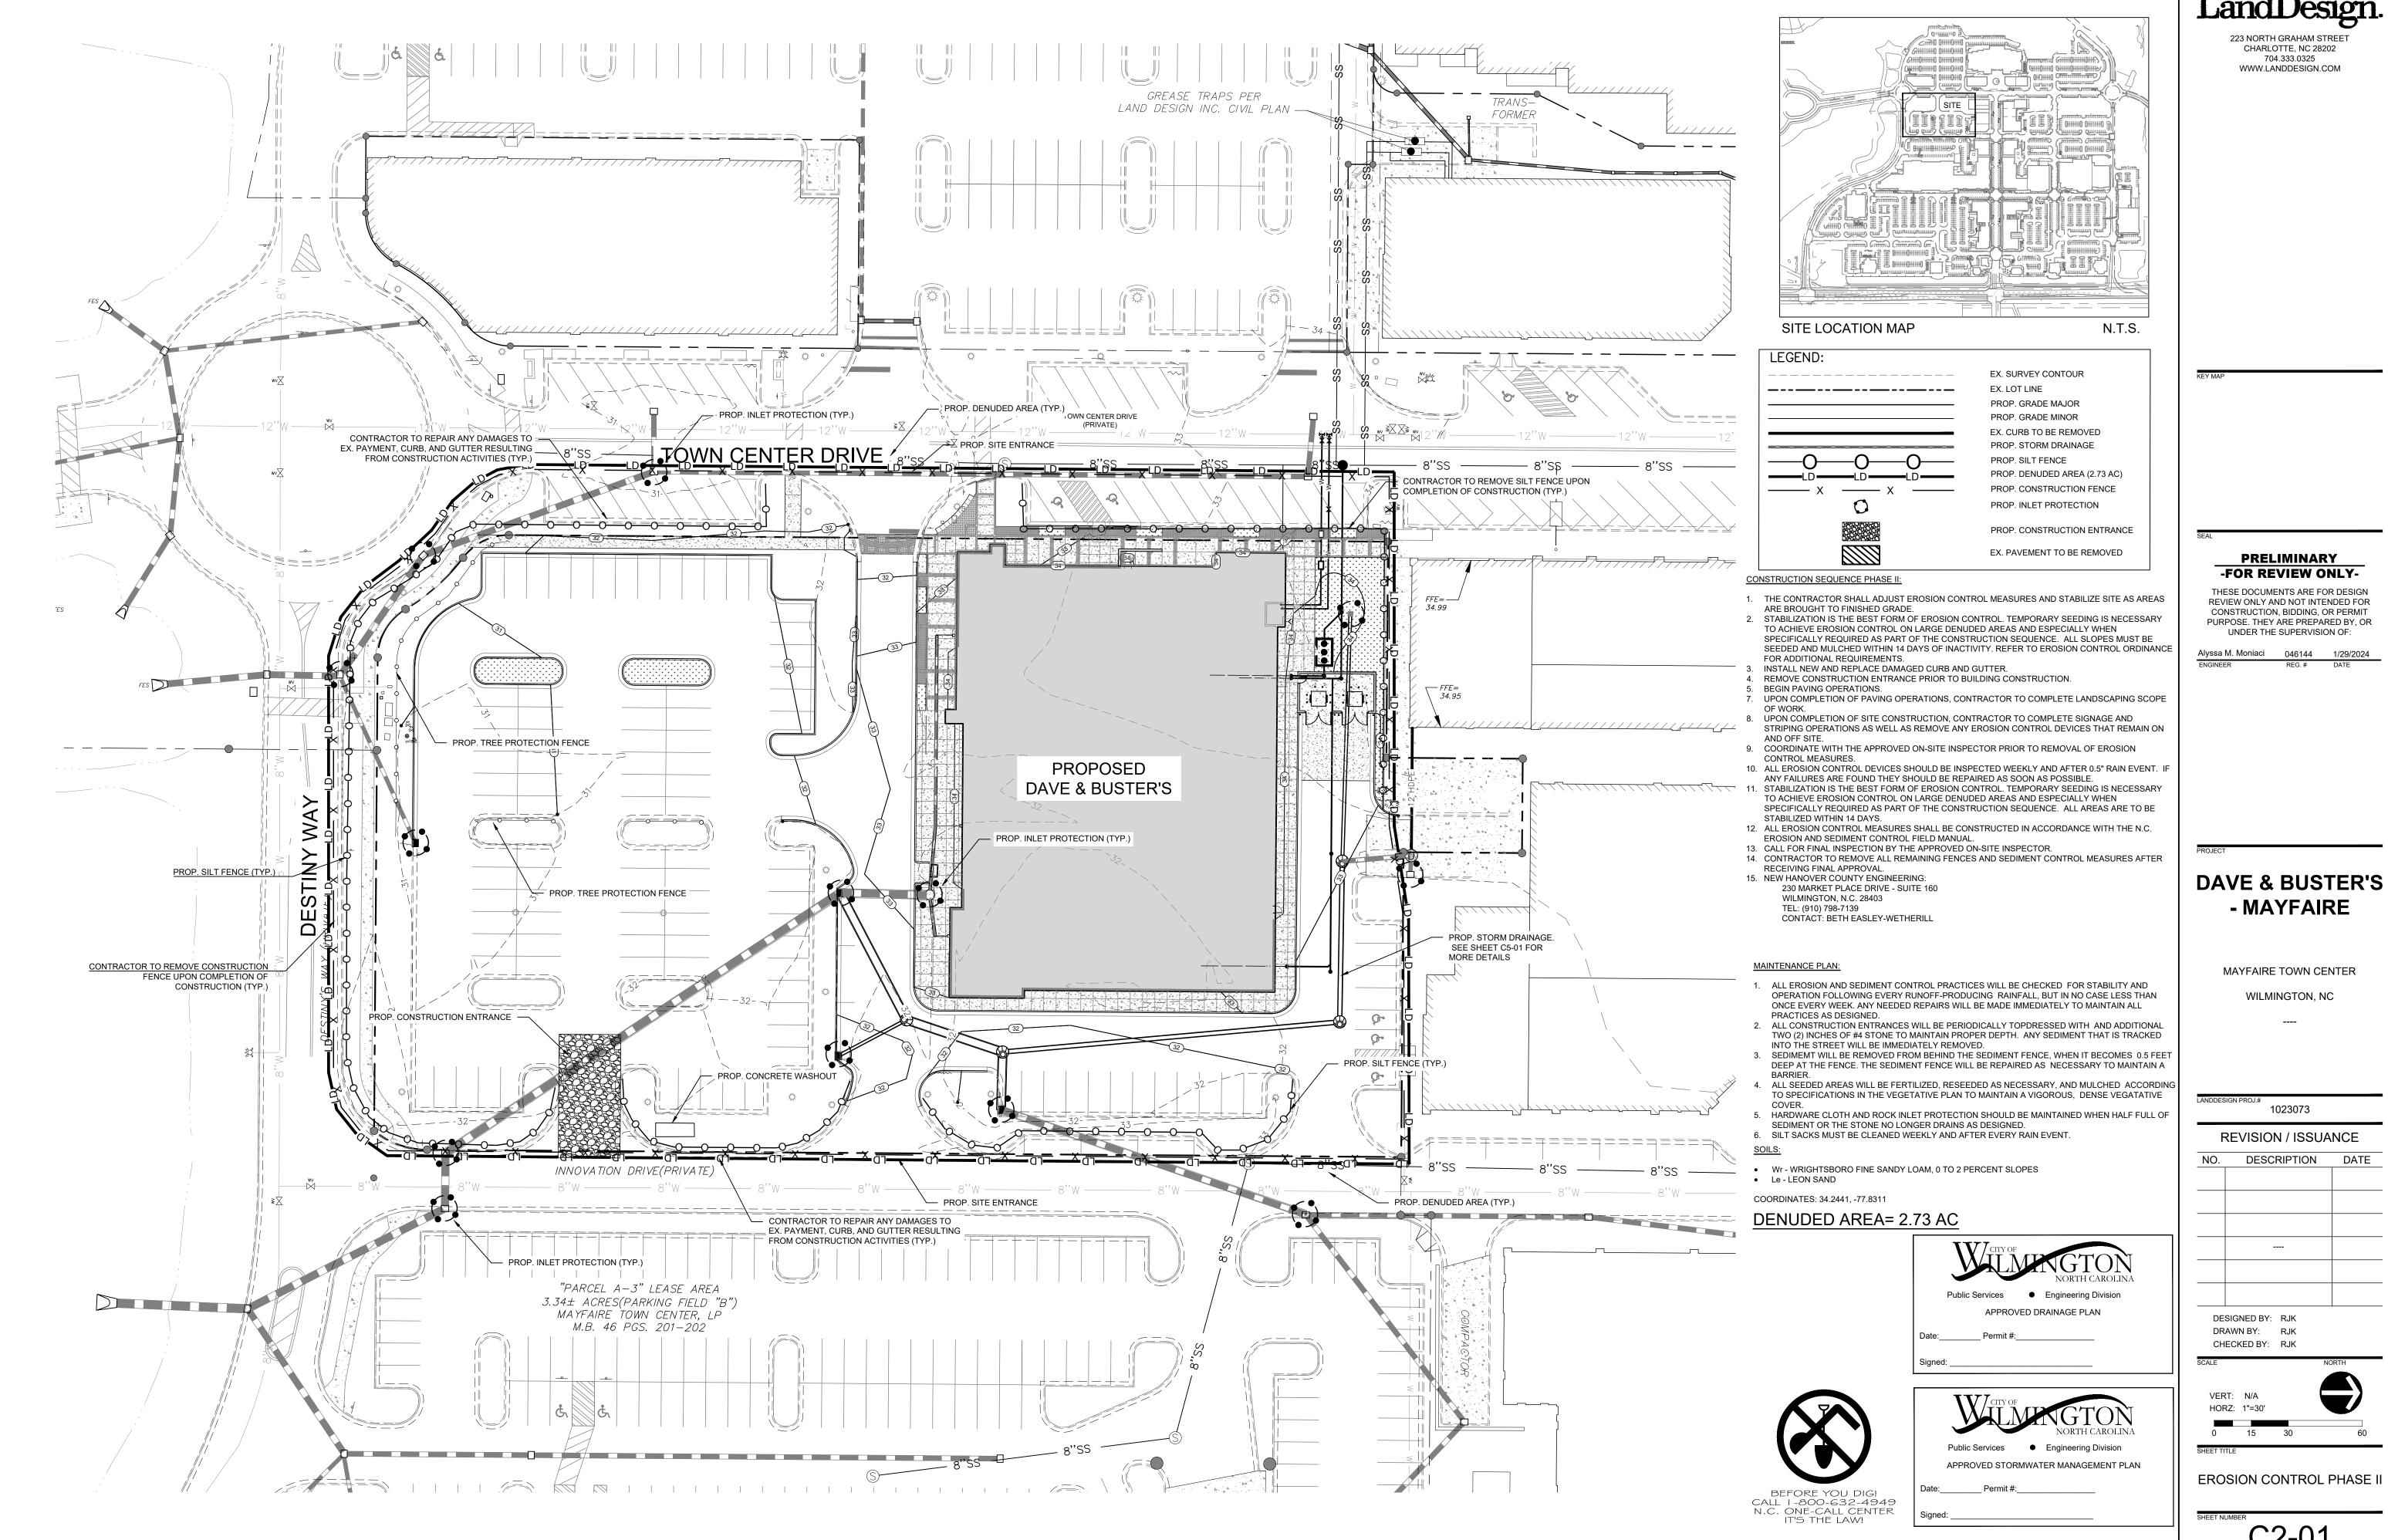

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Alyssa M. Moniaci 046144 1/29/2024

C2-01

ORIGINAL SHEET SIZE: 22" X 34"

GENERAL NOTES:

- FILTER FABRIC FENCE SHALL BE A MINIMUM OF 32" IN WIDTH AND SHALL HAVE A MINIMUM OF 6 LINE WIRES WITH 12" STAY SPACING.
- 2. WOVEN FILTER FABRIC BE USED WHERE SILT FENCE IS TO REMAIN
- 3. STEEL POSTS SHALL BE 5'-0" IN HEIGHT AND BE OF THE
- 4. WIRE FENCING SHALL BE AT LEAST #10 GAGE WITH A MINIMUM OF 6 LINE WIRES WITH 12" STAY SPACING.
- 5. TURN SILT FENCE UP SLOPE AT ENDS.

FXPANSION

RESTRAINT

- 6. WIRE MESH SHALL BE MIN. 13 GAGE WITH MAXIMUM 12" OPENINGS. 7. WIRE AND WASHED STONE WILL BE REQUIRED AND NOTED ON PLANS WHEN:
- A. AT TOE OF SLOPES GREATER THAN 10 FEET VERTICAL (2:1 SLOPE) B. AT DENUDED LIMITS WHERE AN UNDISTURBED BUFFER IS 50 FEET
- 8 ORANGE SAFETY FENCE IS REQUIRED AT BACK OF SILT FENCE WHEN GRADING IS ADJACENT TO SWIM BUFFERS, STREAMS OR WETLANDS (RFFFR TO SWIM BUFFER GUIDELINES). THE COLOR ORANGE IS RESEVED FOR VISUAL IDENTIFICATION OF ENVIRONMENTALLY SENSITIVE AREAS.
- 9. DRAINAGE AREA CAN NOT BE GREATER THAN 1/4 ACRE PER 100FT OF FENCE.
- 10. SLOPE LENGTHS CAN NOT EXCEED CRITERIA SHOWN IN TABLE 6.62A NORTH CAROLINA EROSION AND SEDIMENT CONTROL PLANNING AND DESIGN MANUAL.
- 11. DO NOT INSTALL SEDIMENT FENCE ACROSS STREAMS, DITCHES, WATERWAYS OR OTHER AREAS OF CONCENTRATED FLOW.

OVER TURNDOWN. - STEEL POST ── WIRE FENCING FILTER FABRIC

MAINTENANCE NOTES:

TO THE EXISTING GRADE, PREPARED AND SEEDED

- 1. FILTER BARRIERS SHALL BE INSPECTED BY THE FINANCIALLY RESPONSIBLE PARTY OR HIS AGENT IMMEDIATELY AFTER EACH RAINFALL AND AT LEAST DAILY DURING PROLONGED RAINFALL. ANY REPAIRS NEEDED SHALL BE MADE IMMEDIATELY.
- 2. SHOULD THE FABRIC DECOMPOSE OR BECOME INEFFECTIVE PRIOR TO THE END OF THE EXPECTED USABLE LIFE AND THE BARRIER STILL IS NECESSARY, THE
- FABRIC SHALL BE REPLACED PROMPTLY. 3. SEDIMENT DEPOSITS SHOULD BE REMOVED WHEN DEPOSITS REACH APPROX. HALF THE HEIGHT OF THE BARRIER. ANY SEDIMENT DEPOSITS REMAINING IN PLACE AFTER THE SILT FENCE IS REMOVED SHALL BE DRESSED TO CONFORM


HIGH HAZARD TEMPORARY SILT FENCE

FILTER BAG -

DUMP LOOPS —

- 1. INLET MAINTENANCE SHALL BE DOCUMENTED IN PROJECT LOG BOOK.
- 2. FILTER TYPES SHALL BE APPROVED BY THE COUNTY INSPECTOR PRIOR TO INSTALLATION.
- 3. FILTER BAGS MAY BE REMOVED WHEN SITE IS STABILIZED AT
- THE DIRECTION OF THE ENGINEER.
- 4. FILTER BAGS SHALL BE REMOVED PRIOR TO STREET ACCEPTANCE.
- 5. FILTER BAGS SHALL BE CLEANED OR REPLACED ON A REGULAR BASIS (NOT BE MORE THAN HALF FULL AT ANY TIME).
- 6. FILTER BAGS SHALL NOT BE ALLOWED IN EXISTING CITY OR NCDOT

1" REBAR FOR BAG REMOVAL FROM INLET

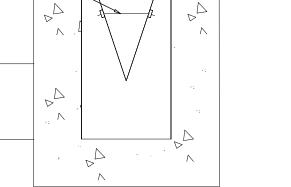


SECTION

INSTALLATION

DEFLECTOR

SILT SACK INLET PROTECTION DETAIL (NOT TO SCALE)

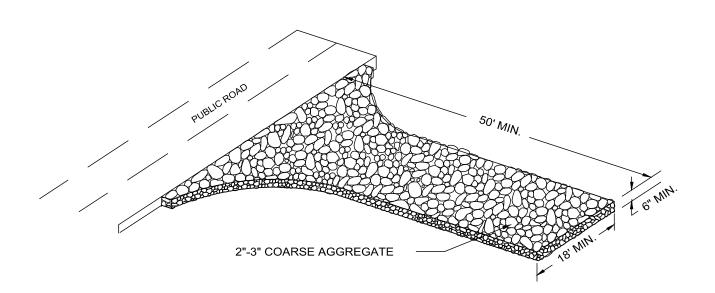

GENERAL NOTES FOR CONSTRUCTION ENTRANCE:

- 1. A STABILIZED ENTRANCE PAD OF #5 WASHED STONE OR RAIL ROAD BALLAST SHALL BE LOCATED WHERE TRAFFIC WILL ENTER OR LEAVE THE
- CONSTRUCTION SITE ONTO A PUBLIC STRFFT 2. FILTER FABRIC OR COMPACTED CRUSHER RUN STONE SHALL BE USED AS
- A BASE FOR THE CONSTRUCTION ENTRANCE. 3. THE ENTRANCE SHALL BE MAINTAINED IN A CONDITION WHICH WILL PREVENT TRACKING OR FLOWING OF SEDIMENT ONTO PUBLIC STREETS OR EXISTING PAVEMENT. THIS MAY REQUIRE PERIODIC TOP DRESSING
- WITH ADDITIONAL STONE AS CONDITIONS DEMAND AND REPAIR AND/OR CLEAN OUT OF ANY MEASURES USED TO TRAP SEDIMENT. 4. ALL SEDIMENT SPILLED, DROPPED, WASHED OR TRACKED ONTO PUBLIC

SHALL BE DONE ON AN AREA STABILIZED WITH CRUSHED STONE.

STREETS MUST BE REMOVED IMMEDIATELY. 5. WHEN APPROPRIATE, WHEELS MUST BE CLEANED TO REMOVE SEDIMENT PRIOR TO ENTERING A PUBLIC STREET. WHEN WASHING IS REQUIRED, IT

STABILIZED CONSTRUCTION ENTRANCE

NOT TO SCALE

EROSION CONTROL NOTES:

- 1. ALL PROPOSED CONTOURS AND SPOT ELEVATIONS REFLECT ROUGH GRADES. 2. ALL ELEVATIONS ARE IN REFERENCE TO THE SURVEYORS BENCHMARK WHICH MUST BE VERIFIED BY
- THE GENERAL CONTRACTOR PRIOR TO GROUND BREAKING 3. ALL EROSION CONTROL MEASURES SHALL BE IN ACCORDANCE WITH THE N.C. EROSION AND SEDIMENT
- CONTROL PLANNING AND DESIGN MANUAL. 4. PERMANENT CUT AND FILL SLOPES PLACED ON A SUITABLE FOUNDATION SHOULD BE CONSTRUCTED
- AT 2:1 (HORIZONTAL TO VERTICAL) OR FLATTER. PERMANENT SLOPES OF 3:1 SHOULD BE CONSTRUCTED WHERE MOWING IS DESIRABLE AND AS INDICATED. 5. IF FILL MATERIAL IS BROUGHT ONTO THE PROPERTY OR IF WASTE MATERIAL IS HAULED FROM THE
- PROPERTY THEN THE CONTRACTOR SHALL DISCLOSE THE LOCATION OF ANY ON-SITE AND/OR OFF-SITE BORROW LOCATION AND/OR WASTE BURIAL LOCATION TO THE EROSION CONTROL INSPECTOR. 6. REFER TO PAVEMENT CROSS-SECTION DATA TO ESTABLISH CORRECT SUB-BASE OR AGGREGATE BASE
- COURSE ELEVATIONS TO BE COMPLETED LINDER THIS CONTRACT 7. LIMITS OF CLEARING SHOWN ARE BASED ON CUT AND FILL SLOPES OR OTHER GRADING REQUIREMENTS.
- 8. ANY GRADING BEYOND THE LIMITS OF CONSTRUCTION SHOWN ON THIS PLAN IS SUBJECT TO A FINE. 9. STABILIZATION IS THE BEST FORM OF EROSION CONTROL. TEMPORARY SEEDING IS NECESSARY TO ACHIEVE EROSION CONTROL ON DENUDED AREAS AND ESPECIALLY WHEN THE CONSTRUCTION SEQUENCE REQUIRES IT. ALL DENUDED AREAS ARE TO BE SEEDED OR LANDSCAPED WITHIN 14
- 10. CONTRACTOR SHALL INSTALL ALL EROSION CONTROL MEASURES AS INDICATED PRIOR TO GRADING OPERATIONS. NO DEVICE MAY BE REMOVED UNTIL SITE IS STABILIZED.
- 11. CONTRACTOR SHALL BLEND NEW EARTHWORK SMOOTHLY WITH EXISTING CONTOURS. 12. GRADING MORE THAN 1 ACRE WITHOUT AN APPROVED EROSION CONTROL PLAN IS A VIOLATION AND
- 13. SOIL TYPES: Le LEON To TORHUNTA Wr WRIGHTSBORO 14. ALL DISTANCES ARE HORIZONTAL GROUND.
- 15. SITE IS LOCATED IN THE HOWE CREEK & BRADLEY CREEK WATERSHED AREAS (GWA). 16. CONTRACTOR SHALL VERIFY SPOTS AND NOTIFY THE ENGINEER IMMEDIATELY OF ANY GRADE DISCREPANCIES PRIOR TO POURING ANY CURB & GUTTER OR PAVE ANY AREAS THAT MAY BE
- 17. TOTAL SITE AREA: 2.67 AC

SUBJECT TO A FINE.

TOTAL DENUDED AREA: ±3.63 AC 18. CONTRACTOR IS RESPONSIBLE FOR MONITORING THE EROSION CONTROL WORK DURING THE COURSE OF CONSTRUCTION TO INSURE THAT ALL WORK HAS BEEN PROPERLY INSTALLED AND MAINTAINED.

ADDITIONAL GENERAL NOTES:

- LAND DEVELOPMENT INSPECTOR TO BE GIVEN 24 HOURS NOTICE PRIOR TO START OF CONSTRUCTION. COORDINATE ALL CURB AND STREET GRADES IN HANDICAP WITH INSPECTOR.
- ALL ROAD IMPROVEMENTS TO BE COORDINATED WITH ENGINEERING DEPARTMENT PRIOR TO CONSTRUCTION. DEVELOPER WILL PROVIDE STREET SIGNS (9" SIGNS ONLY). SIGHT TRIANGLES ARE THE MINIMUM REQUIRED.
- IN ROLLING AND HILLY TERRAIN, SWEEPING OF THE STONE BASE AND/OR APPLICATION OF A TACK COAT MAY BE REQUIRED NEAR INTERSECTIONS. THESE REQUIREMENTS WILL BE ESTABLISHED BY THE INSPECTOR
- APPROVAL OF THIS PLAN IS NOT AN AUTHORIZATION TO GRADE ADJACENT PROPERTIES. WHEN FIELD CONDITIONS WARRANT OFF-SITE GRADING, PERMISSION MUST BE OBTAINED FROM THE ADJACENT PROPERTY OWNERS AND NEW HANOVER COUNTY EROSION CONTROL OFFICE.
- IN ORDER TO ENSURE PROPER DRAINAGE, KEEP A MINIMUM OF 0.5 % SLOPE ON THE CURB SUBSURFACE DRAINAGE FACILITIES MAY BE REQUIRED IN THE STREET RIGHT-OF-WAY IF DEEMED NECESSARY BY THE INSPECTOR. 10. PIPE SYSTEMS LOCATED WITHIN PERMANENT STORM DRAINAGE EASEMENTS IN THE (CITY/COUNTY) ARE TO BE
- MAINTAINED BY THE (CITY/COUNTY) IN AN "ON-CALL" MANNER. THE (CITY/COUNTY) WILL NEITHER BE I. ANY BUILDING WITHIN THE 100+1 BUILDING RESTRICTION FLOOD LINE IS SUBJECT TO THE RESTRICTIONS OF THE (CITY OF WILMINGTON/NEW HANOVER COUNTY) SUBDIVISION ORDINANCE. SECTION 7.200.8. ANY CONSTRUCTION OR USE WITHIN THE AREAS DELINEATED AS FLOODWAY DISTRICT FRINGE BOUNDARY LINE OR
- FLOODWAY DISTRICT ENCROACHMENT BOUNDARY LINE IS SUBJECT TO THE RESTRICTIONS IMPOSED BY THE FLOODWAY REGULATIONS OF THE CITY OF WILMINGTON AND NEW HANOVER COUNTY. 12. ALL OPENINGS (E.G., DOORS, WINDOWS, VENTS) IN STRUCTURES BUILT ON LOTS (NONE) SHOULD BE LOCATED A MINIMUM OF ONE FOOT ABOVE THE ADJACENT FINISHED GROUND SURFACE. (APPLIES TO LOTS WHICH MAY
- EXPERIENCE SIGNIFICANT OVERLAND FLOW NOT CONSIDERED IN THE 100+1 FLOOD ANALYSIS) 13. THE (CITY OF WILMINGTON/NEW HANOVER COUNTY) ENGINEERING DEPARTMENT HAS NOT REVIEWED THE STRUCTURAL STABILITY OF ANY RETAINING WALLS ON THE SITE AND DOES NOT ASSUME RESPONSIBILITY FOR

SPECIAL CONDITIONS

- 1. ALL THE SOIL EROSION CONTROL MEASURES WILL BE INSTALLED AS THE SITE IS CLEARED AND MAINTAINED THROUGHOUT CONSTRUCTION.
- THIS PERMIT DOES NOT PRECLUDE ANY PERMITS OR APPROVALS WHICH MAY BE NECESSARY SUCH AS DEM WATER QUALITY, C.A.M.A., THE CORPS OF ENGINEERS, DEM SOILD WASTE OR ANY OTHER AGENCIES
- NO SEDIMENT SHALL LEAVE THE SITE OR ENTER THE WETLANDS IN ANY EVENT. 4. IF PLAN REVISIONS ARE NECESSARY YOU MUST SUBMIT A COPY TO THE NEW HANOVER COUNTY
- EROSION CONTROL OFFICE FOR APPROVAL PRIOR TO ANY FIELD CHANGES. 5. IF SOIL IS REMOVED FROM THE SITE, IT MUST BE TAKEN TO AN APPROVED OR PERMITTED SITE TO
- BE IDENTIFIED BY THE NEW HANOVER COUNTY EROSION CONTROL OFFICE PRIOR TO REMOVAL 6. ALL CITY AND STATE DRAINAGE AND STORMWATER REQUIREMENTS WILL BE ADHERED TO.
- IF THESE MEASURES FAIL TO ADEQUATELY CONTROL EROSION, MORE RESTRICTIVE MEASURES WILL BE REQUIRED. 8. IF ANY PHASE OF GRADING CEASES FOR MORE THAN 14 CALENDAR DAYS, THE SITE WILL BE
- TEMPORARILY STABILIZED. 9. THE APPROVAL OF AN EROSION CONTROL PLAN IS CONDITIONED ON THE APPLICANTS
- COMPLIANCE WITH FEDERAL AND STATE WATER QUALITY LAWS REGULATIONS AND RULES. 10. ALL SLOPES WILL BE STABILIZED WITHIN 14 CALENDAR DAYS OF CEASE OF ANY ACTIVITY

STABILIZATION NOTES

GENERAL NOTES:

1. ALL SLOPES WILL BE STABILIZED WITHIN 14 CALENDAR DAYS.

UNIFORMLY GRADE A SHALLOW

DEPRESSION APPROACHING THE

2. DRIVE 5-FOOT STEEL POSTS 2 FEET

THE PERIMETER OF THE INLET, A

MAXIMUM OF 4 FEET APART.

3. SURROUND THE POSTS WITH WIRE

THE WIRE MESH TO THE STEEL

OF THE WIRE MESH UNDER THE

4. PLACE CLEAN GRAVEL (NC DOT #5

OR #57 STONE) ON A 2:1 SLOPE WITH A HEIGHT OF 16 INCHES

ONCE THE CONTRIBUTING DRAINAGE

6. COMPACT THE AREA PROPERLY AND

STABILIZED IT WITH GROUNDCOVER.

ACCUMULATED SEDIMENT, AND

ESTABLISH FINAL GRADING

AROUND THE WIRE, AND SMOOTH TO

AREA HAS BEEN STABILIZED, REMOVE

GRAVEL FOR ANCHORING IS

RECOMMENDED.

AN EVEN GRADE.

ELEVATIONS.

MESH HARDWARE CLOTH. SECURE

POSTS AT THE TOP, MIDDLE, AND

BOTTOM. PLACING A 2-FOOT FLAP

NCDOT #5 OR #57

NCDOT #5 OR #57

WASHED STONE-

TEMPORARY FABRIC DROP INLET PROTECTION

NOT TO SCALE

WASHED STONE-

INTO THE GROUND SURROUNDING THE

INLET. SPACE POSTS EVENLY AROUND

SEEDING SPECIFICATION

SEEDING CAN BE USED FOR TEMPORARY OR PERMANENT STABILIZATION. DISTURBED AREAS OF THE SITE WHERE CONSTRUCTION ACTIVTY HAS CEASED FOR MORE THAN 14 DAYS (OR MORE FREQUENT IF REQUIRED BY THE STATE NPDES PERMIT) SHALL BE TEMPORARILY SEEDED AND WATERED. AREAS WHERE FINAL GRADING HAS BEEN COMPLETED FOR MORE THAN 14 DAYS SHALL BE TEMPORARILY OR PERMANENTLY SEEDED. ALL DISTURBED AREAS ON SLOPES GREATER THAN 3:1 MUST BE TEMPORARILY SEEDED AFTER 7 DAYS. ALL PERIMETER DIKES, SWALES, DITCHES AND SLOPES MUST BE TEMPORARILY SEEDED AFTER 7 DAYS. TEMPORARY SEED MIXTURES ARE SPECIFIED BELOW. PERMANENT SEED MIXTURES SHALL BE SEEDED DURING SEASON SPECIFIED

PERMANENT SEEDING SPECIFICATIONS - (PS)

LOW MAINTENANCE AREAS

HIGH MAINTENANCE AREAS

STEEP SLOPES OR STONY, SHALLOW OR DRY SOILS **DATES** 100 LB/ACRE TALL FESCUE AUG. 25 - SEPT. 15 30 LB/ACRE FEB. 15 - MAR. 21 SERICEA LESPEDEZA 10 LB/ACRE KOBE LESPEDEZA

DATES AUG 25 - SEPT 15 TALL FESCUE 80 LB/ACRE FEB. 15 - MAR. 21 SERICEA LESPEDEZA 20 LB/ACRE KOBE LESPEDEZA 10 LB/ACRE

GENTLE SLOPES, AVERAGE SOILS

GENTLE SLOPES, SOILS WITH AVERAGE OR BETTER MOISTURE, COOL SITES DATES BLEND OF TWO TURF-TYPE AUG. 25 - SEPT. 15 200 - 250 LB/ACRE TALL FESCUES (90%) AND

TWO OR MORE KENTUCKY BLUEGRASS VARIETIES (10%) GENTLE SLOPES, DRIER SOILS, PHYSICAL LIMITATIONS

AUG. 25 - SEPT. 15 BLEND OF 50% KY-31 TALL 200 - 250 LB/ACRE FESCUE AND 50% MIXTURE OF TWO OR MORE TURF TYPE TALL FESCUES

GRASS-LINED CHANNELS, AVERAGE SOILS

DATES AUG. 25 - OCT. TALL FESCUE 200 LB/ACRE OR 4 - 5 LB/1000 SF GRASS-LINED CHANNELS, DRY SOILS

DATES APRIL 15 - JUNE 30 ANNUAL RYE PLANTED 40 - 80 LB/ACRE OR WITH PERMANANT SEEDING OF FESCUES IN FALL 1 - 2 LB/1000 SF

AMENDMENTS SHALL BE APPLIED AT THE RATE OF 4000 LB/ACRE OF GROUND AGRICULTURAL LIMESTONE AND 1000 LB/ACRE OF 10-10-10 FERTILIZER. DRY SOIL, GRASS-LINED CHANNELS SHALL USE 3000 LB/ACRE OF GROUND AGRICULTURAL LIMESTONE AND 500 LB/ACRE OF 10-10-10 FERTILIZER. MULCH SHALL BE APPLIED AT THE RATE OF 4000 LB/ACRE OF STRAW. STRAW SHALL BE ANCHORED BY TACKING WITH MULCH ANCHORING TOOL. TACKING USES LIQUID MULCH BINDERS TO ANCHOR HAY OR STRAW MULCHES. THESE VEGETABLE-BASED TRACKIFIERS ARE NATURAL ORGANIC INGREDIENTS THAT ACT AS "GLUE" TO HOLD THE STRAW IN PLACE. TACK IS APPLIED BY THE HYDROSEEDER ALONG WITH WOOD FIBER MULCH AND WATER. WOOD FIBER MULCH ACTS AS AN ADDITIONAL BINDER, AND WITH ITS HARMLESS TEMPORARY GREEN DYE. PRIVODES OUR INSTALLERS WITH A VISUAL GUIDE TO ASSURE UNIFORM COVERAGE. JUTE OR EXCELSIOR MATTING SHALL BE USED IN GRASS LINED CHANNELS TO CALCULATED HIGH WATER

TEMPORARY SEEDING SPECIFICATIONS - (TS) DATES

RYE (GRAIN) JAN. 1 - MAY 1 FEB. 15 - MAR. 21 ANNUAL LESPEDEZA

2000 LB/ACRE GROUND 120 LB/ACRE AGRICULTURAL LIME- STONE 50 LB/ACRE AND 750 LB/ ACRE OF 10-10-10 FERTILIZER

DATES MAY 1 - AUG. 15

- 4' MAX.

FILTERED

DATES

2000 LB/ACRE GROUND

19-GAUGE HARDWARE CLOTH

(1" MESH OPENINGS)

16" MIN.

AMENDMENTS

RATE

2000 LB/ACRE GROUND AUG. 15 - DEC. 30 RYE (GRAIN) 120 LB/ACRE AGRICULTURAL LIME- STONE AND 1000 LB/ ACRE OF 10-10-10 FERTILIZER

40 LB/ACRE **GERMAN MILLET** AGRICULTURAL LIME- STONE AND 750 LB/ ACRE OF 10-10-10


- unless no reasonable alternatives available Earthen-material stockpiles must be located 50' from storm drains and streams unless no reasonable alternatives
- surface waters, wetlands, or buffers.

The permit allows reduction from the 20 acre minimum if the Director of DWQ determines that other BMPs provide equivalent protection

- Same rain gauge & inspections after 0.5" rain event
- Inspections are only required during "normal business
- business hours unless a site-specific exemption is Records must be kept for 3 years and available upon

- can follow conditions of approved application. Applications received after August 2, 2011 must compl

APPROVED DRAINAGE PLAN

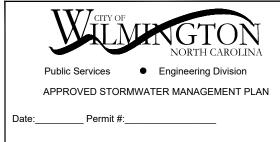

HYDROSEEDING APPLICATION: TWO STEP PROCESS

100% CELLULOSE OR WOOD FIBER FERTILIZER (FERTILIZER 10-10-10) 500 LBS SEED AS PER SECTION (FOLLOW SEEDING ___ LBS SPECIFICATION)

A. ALL HYDROSEED APPLICATIONS ARE TO BE APPLIED IN A SWEEPING MOTION TO FORM A UNIFORM APPLICATION AND FORM A MAT AT THE SPECIFIED RATES. B. UNUSED LOADS: IF MIXTURE REMAINS IN TANK FOR MORE THAN 8 HOURS IT SHALL BE REMOVED FROM THE JOB SITE AT CONTRACTOR'S EXPENSE.

STEP 1 - $\frac{1}{3}$ MULCH, ALL SEEDING AND ALL INOCULANT SPREAD IN ONE DIRECTION STEP 2 - 2 MULCH RATE APPLIED IN OPPOSING DIRECTION

SEED BED PREPARATION (PERMANENT SEEDING)

SURFACE WATER CONTROL MEASURES SHALL BE IN PLACE. AREA TO BE SEEDED SHALL BE RIPPED AND SPREAD WITH AVAILABLE TOPSOIL. TOTAL SEEDBED PREPARED DEPTH SHOULD BE AT LEAST 4 INCHES. LOOSE ROCKS, ROOTS AND OTHER OBSTRUCTIONS NEED TO BE REMOVED FROM THE SURFACE SO THAT THEY WILL NOT INTERFERE WITH THE ESTABLISHMENT AND MAINTENANCE OF VEGETATION. SURFACE FOR FINAL SEEDBED PREPARATION SHOULD BE AT FINISH GRADE AND BE REASONABLY SMOOTH AND UNIFORM

IF NO SOIL TEST IS TAKEN, FERTILIZER AND LIME SHOULD BE ACCORDING TO SEEDING SPECIFICATIONS. IF SOIL TEST IS TAKEN, APPLY FERTILIZER AND LIME ACCORDING TO SOIL TEST REPORT. FERTILIZER AND LIME SHALL BE APPLIED UNIFORMLY AND MIXED WITH THE SOIL DURING SEEDBED PREPARATION. WEIGHTS, SEED SPECIES AND RATE AS A PERCENTAGE OF PURITY AND GERMINIATION MUST BE CHECKED PRIOR TO

SEEDING SHALL BE ACCOMPLISHED IN TWO DIRECTIONS AND AT RIGHT ANGLES TO EACH OTHER. LAWN AREAS SHALL BE SEEDED AT THE RATE INDICATED ON THE DRAWINGS BY SOWING EVENLY WITH AN APPROVED MECHANICAL CULTI-PACKER SEEDER TO COVER THE SEED AND FORM THE SEEDBED IN ONE OPERATION. IF BROADCAST SEEDER IS USED THE SEEDING RATE SHALL BE TWO (2) TIMES THE DRILL RATE. IN INACCESSIBLE AREAS, THE SEED SHALL BE LIGHTLY RAKED WITH FLEXIBLE RAKES AND ROLLED WITH A WATER BALAST ROLLER. AFTER ROLLING SEEDED AREAS ARE TO BE MULCHED ACCORDING TO SPECIFICATION. IF HYDROSEED OPERATION IS USED, SEEDING RATE SHALL BE FIVE (5) TIMES THE DRILL RATE INDICATED ON THE DRAWINGS.

IF SEEDING CAN NOT BE ACCOMPLISHED DUE TO SEASONAL CONSTRAINTS, APPLY STRAW MULCH AND TACKIFIER TO ALL SLOPES AND DISTURBED AREAS LINTIL PERMANENT SEEDING IS ALLOWED. IN THE EVENT SEEDING OCCURS OUT OF SEASON, MAINTENANCE SHALL OCCUR AND CONTINUE INTO THE FOLLOWING GROWING SEASON OR UNTIL A UNIFORM STAND OF THE SPECIFIED PERMANENT GRASSES HAVE BEEN ESTABLISHED AND THE SITE HAS REACHED 85% STABILIZATION. PERMANENT AND TEMPORARY SEEDING SHALL BE ACCOMPLISHED THROUGHOUT THE CONSTRUCTION

INSPECTION

INSPECT SEEDED AREAS FREQUENTLY. IF SEEDED AREAS FAIL TO GERMINATE, OR TO PROVIDE ADEQUATE GROUND COVERAGE, THE AREA SHALL BE RE-SEEDED UNTIL FINAL STABILIZATION IS ACHIEVED. ALL EROSION AND SEDIMENT CONTROL MEASURES SHALL BE INSPECTED AT MINIMUM EVERY SEVEN (7) CALENDAR DAYS AND WITHIN 24-HOURS OF A RAINFALL EVENT OF.5 INCHES AND GREATER OF RAIN DURING A 24-HOUR PERIOD (OR MORE FREQUENTLY IF REQUIRED BY THE STATE NPDES GENERAL PERMIT) THROUGHOUT CONSTRUCTION UNTIL FINAL STABILIZATION IS ACHIEVED OR

NPDES GENERAL NOTES:

MORE FREQUENTLY IF REQUIRED BY STATE NPDES GENERAL PERMIT.

	Site Area Description	Stabilization Time Frame	Stabilization Time Frame Exceptions
•	Perimeter dikes, swales, ditches and slopes	7 days	None
•	High Quality Water (HQW) Zones	7 days	None
•	Slopes steeper than 3:1	7 days	If slopes are 10' or less in length and ar not steeper than 2:1 14 days are allowed
•	Slopes 3:1 or flatter	14 days	7-days for slopes greater than 50 feet in length
	All other areas with slopes flatter than 4:1	14 days	None (except for perimeters and HQW Zones)

2) Building Wastes Handling

- No paint or liquid wastes in stream or storm drains
- Dedicated areas for demolition, construction and other wastes must be located 50' from storm drains and streams
- · Concrete materials must be controlled to avoid contact with

3) Discharges to Federally-listed Waters Requirements are the same as in previous permit.

4) Inspections

- Same weekly inspection requirements
- Inspection reports must be available on-site during

Electronically-available records may be substituted under certain conditions

5) Implementation of New Permit Conditions

- Projects permitted under the previous permit can continue to follow the previously-permitted conditions Complete applications received prior to August 3, 2011
- with new permit conditions.

DESIGNED BY: RJK DRAWN BY: RJK CHECKED BY: RJK VERT: N/A HORZ: N/A

EROSION CONTROL DETAILS

C2-02

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DAVE & BUSTER'S

- MAYFAIRE

MAYFAIRE TOWN CENTER


WILMINGTON, NC


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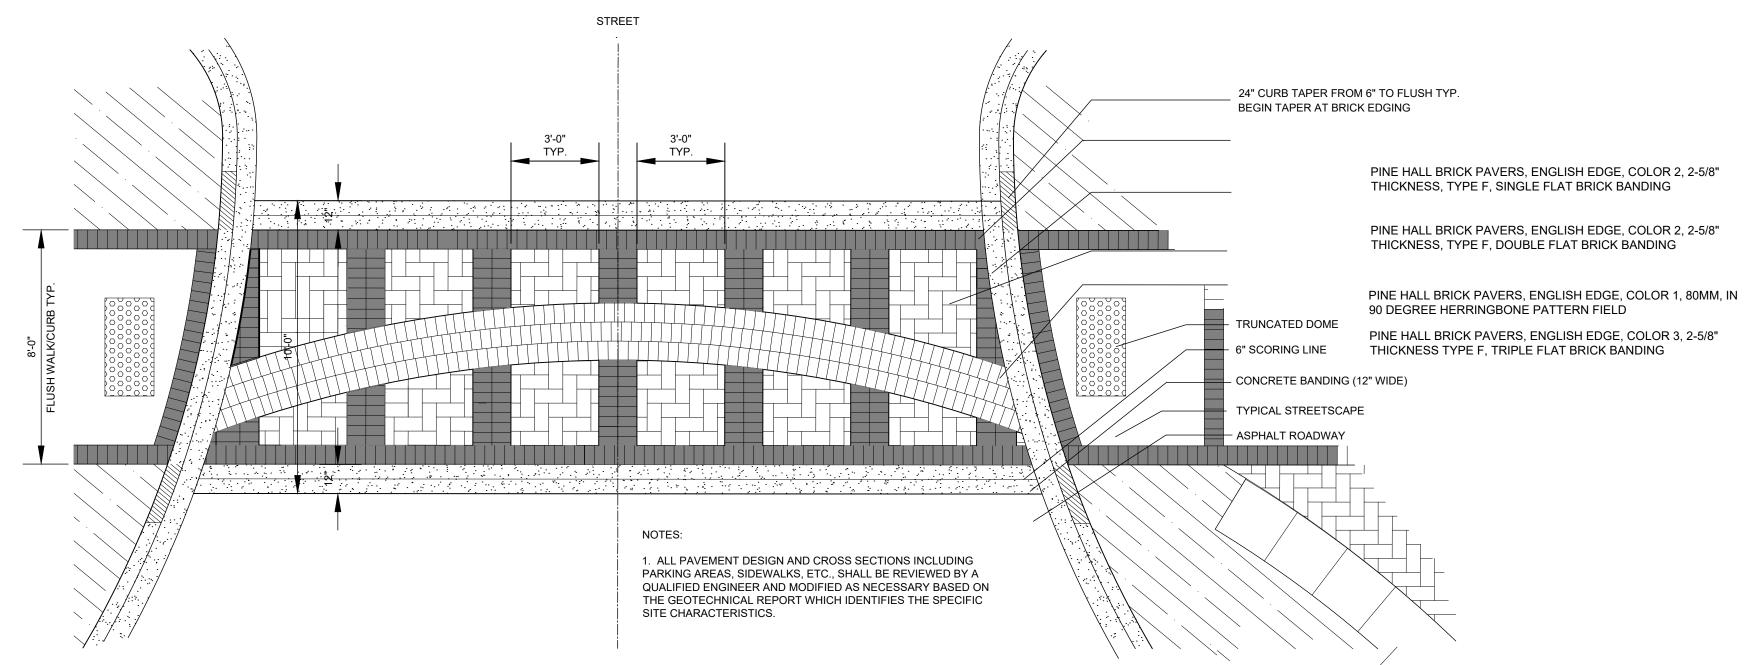
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NO. DESCRIPTION DATE

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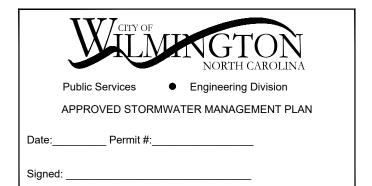




TYPICAL PAVER CROSSWALK
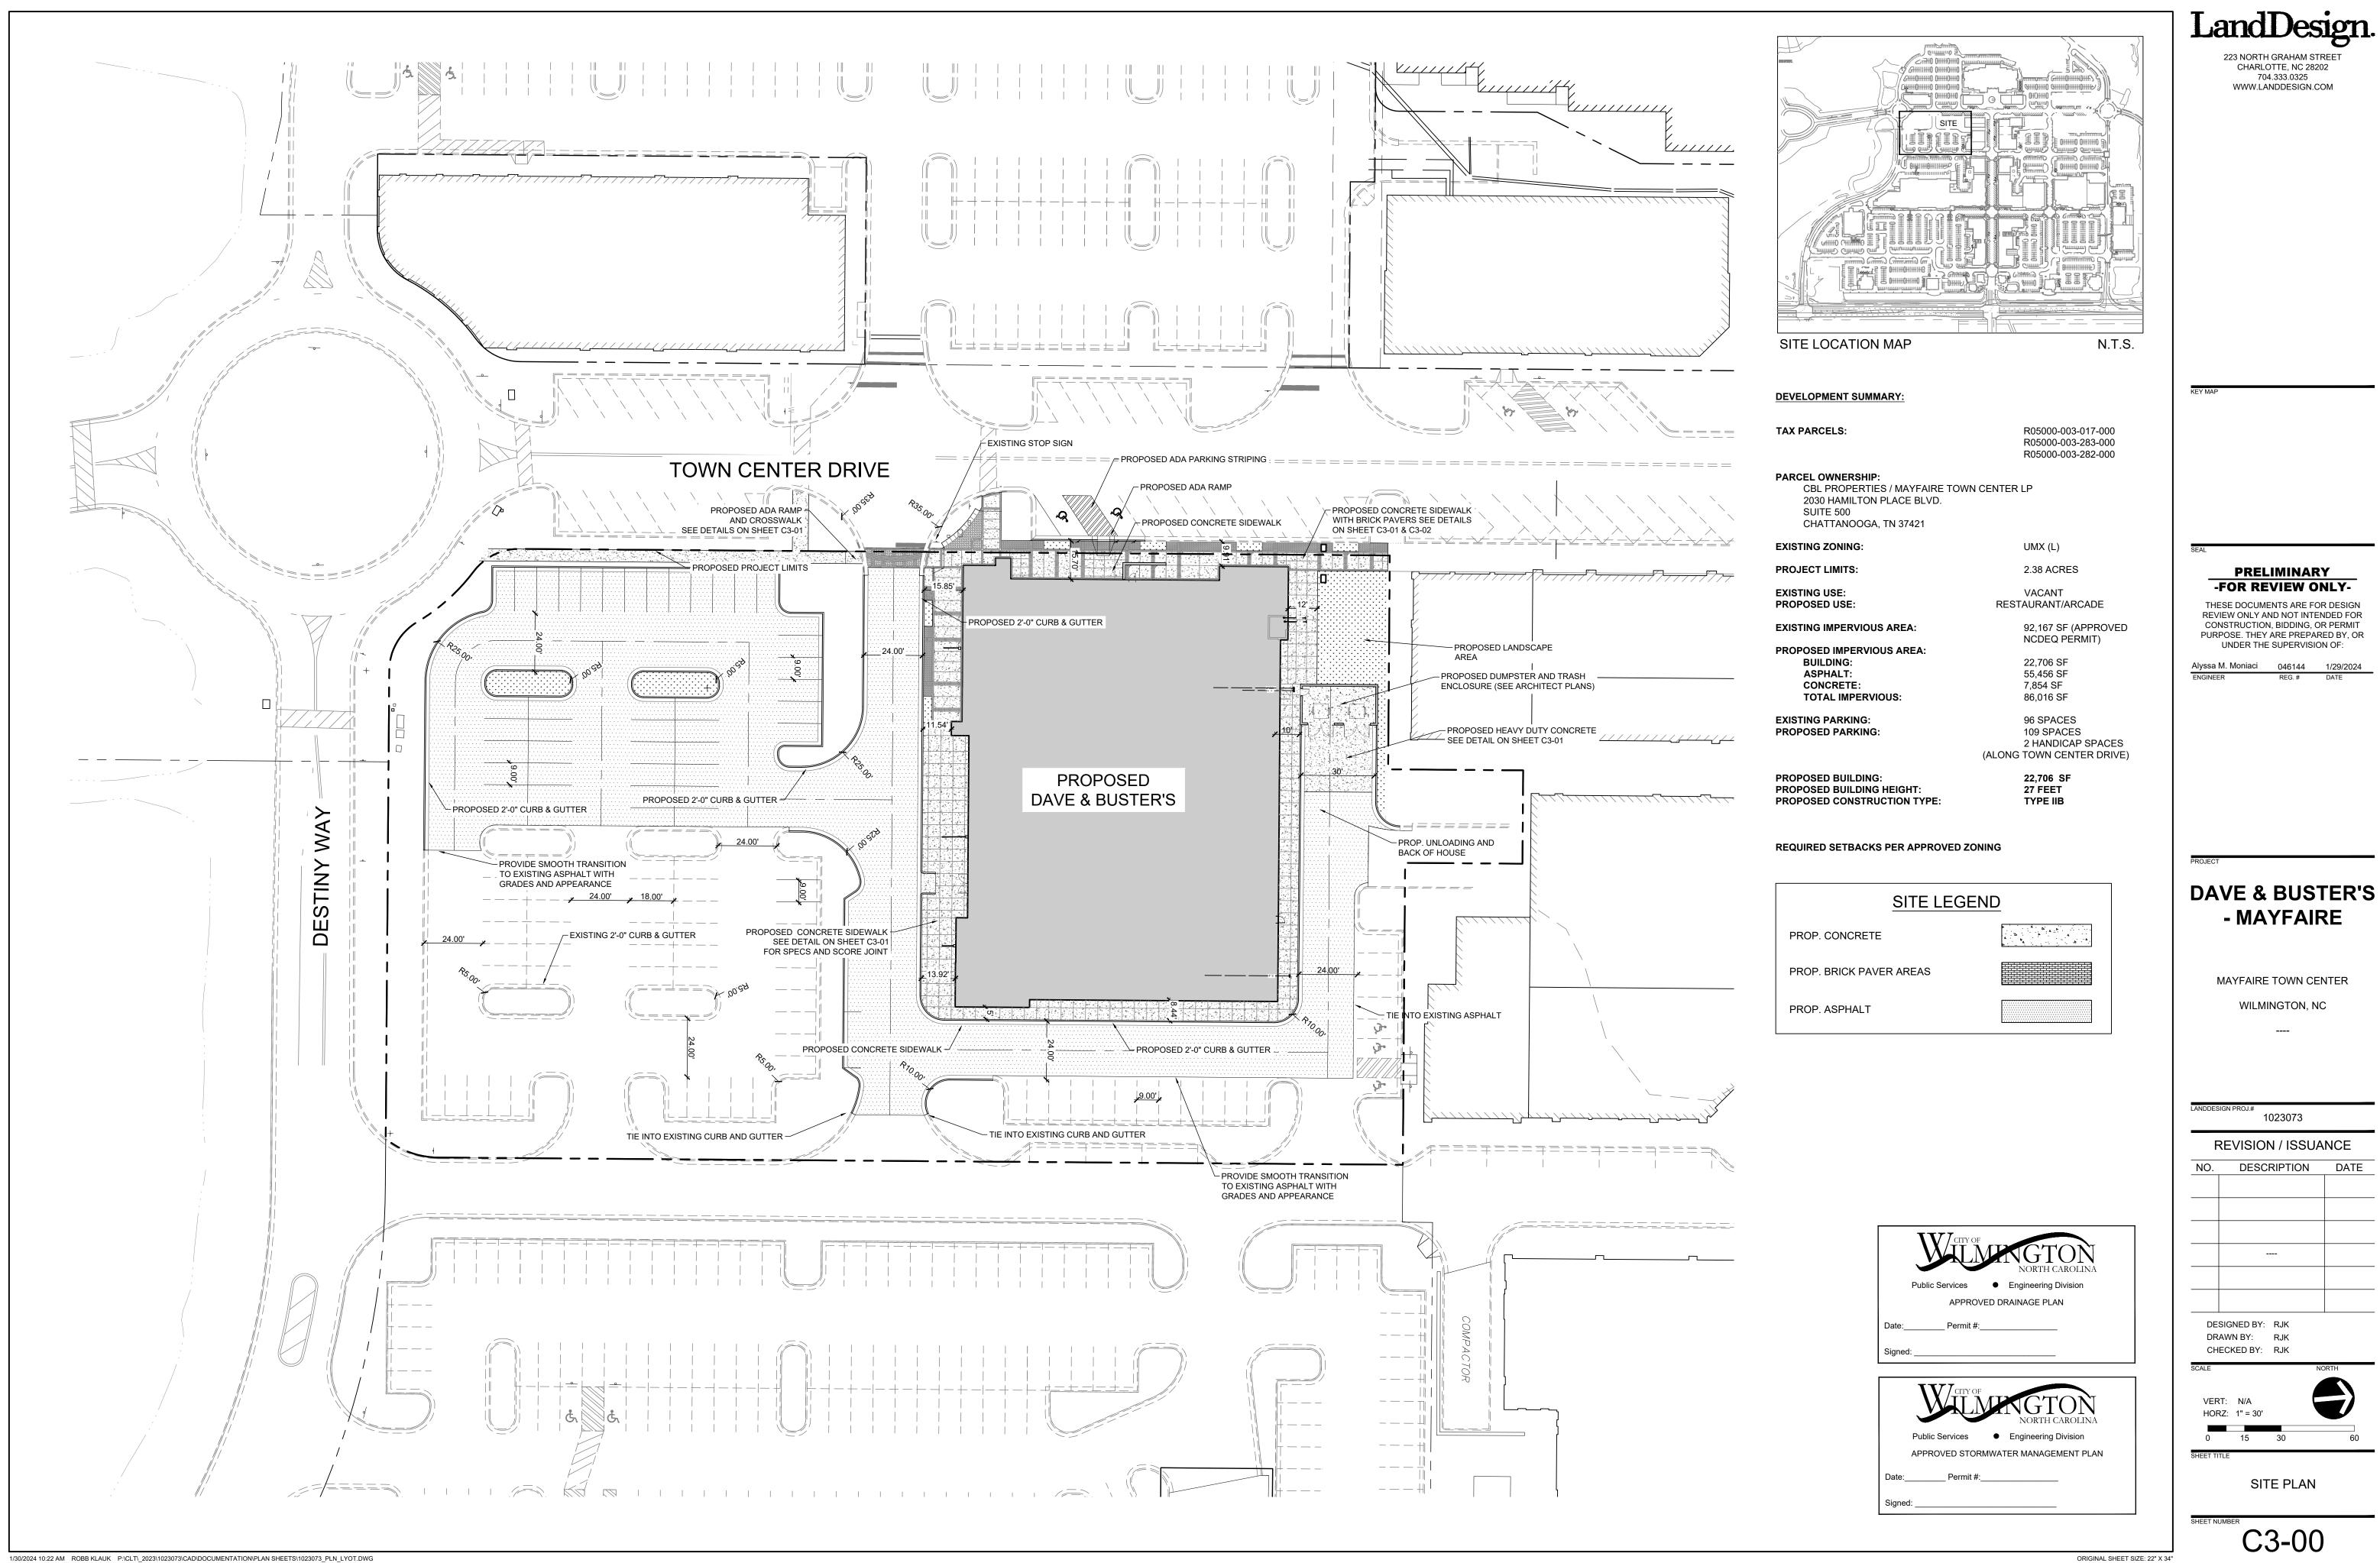
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- MAYFAIRE

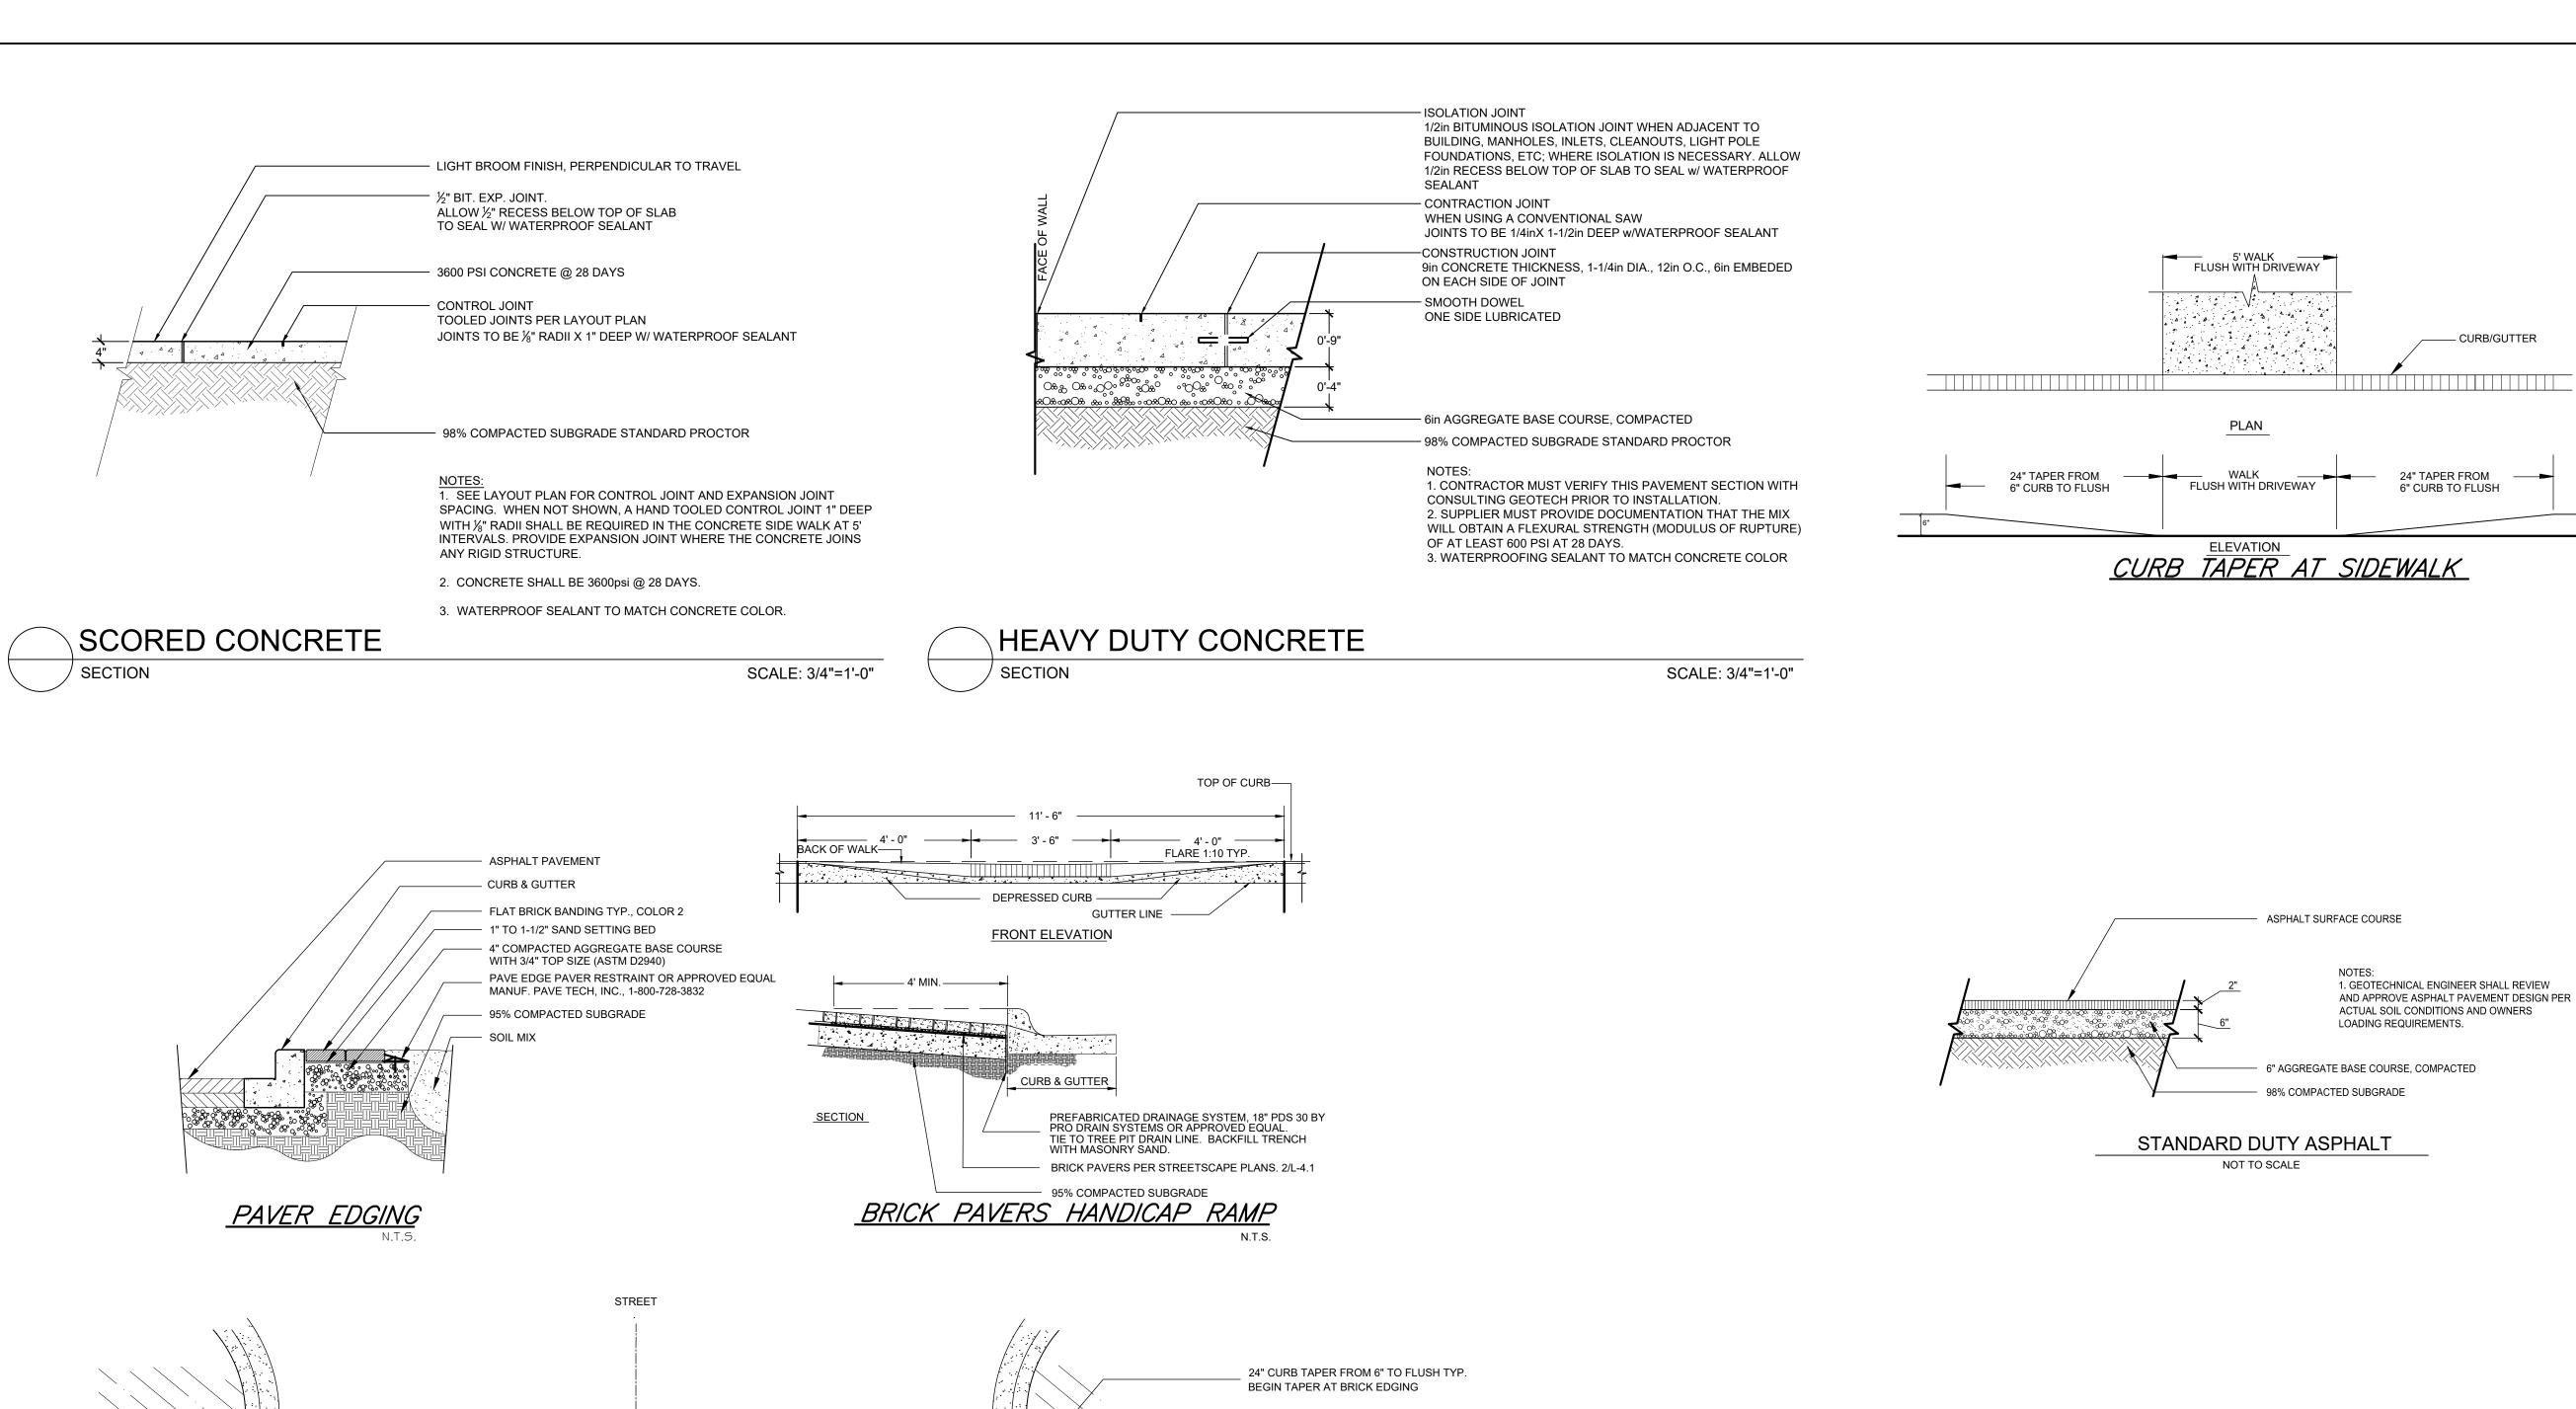MAYFAIRE TOWN CENTER

WILMINGTON, NC

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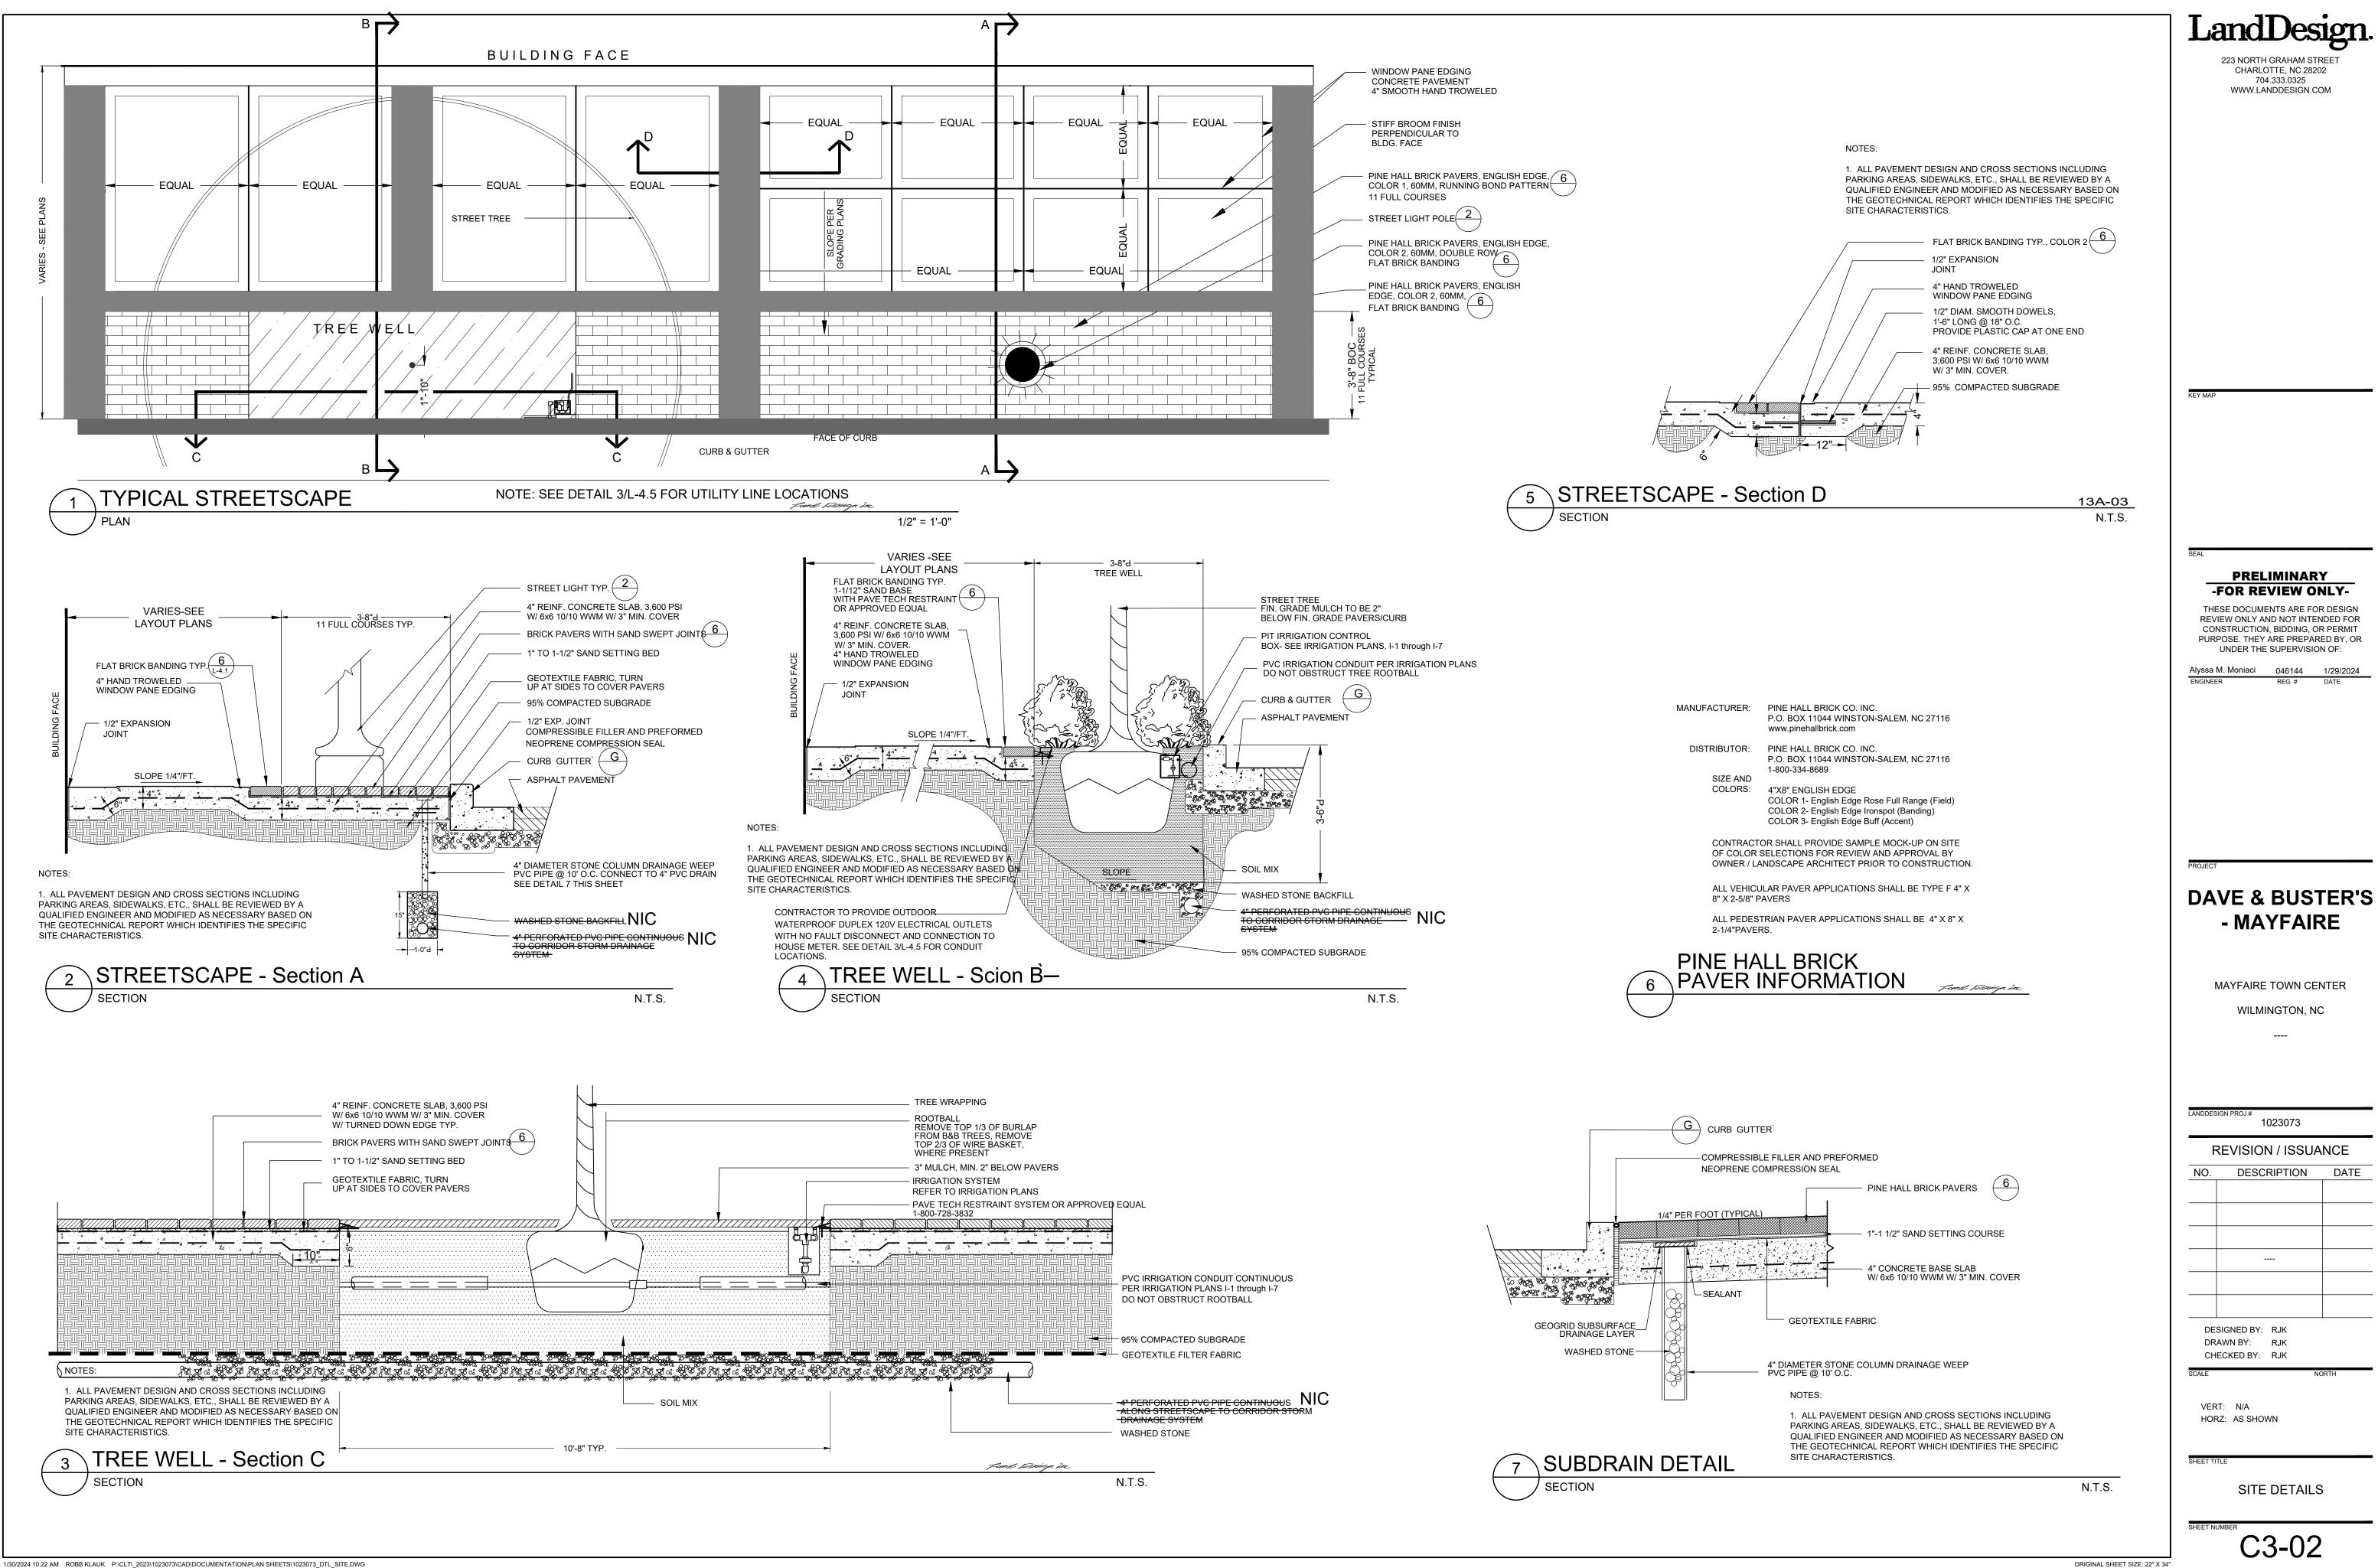
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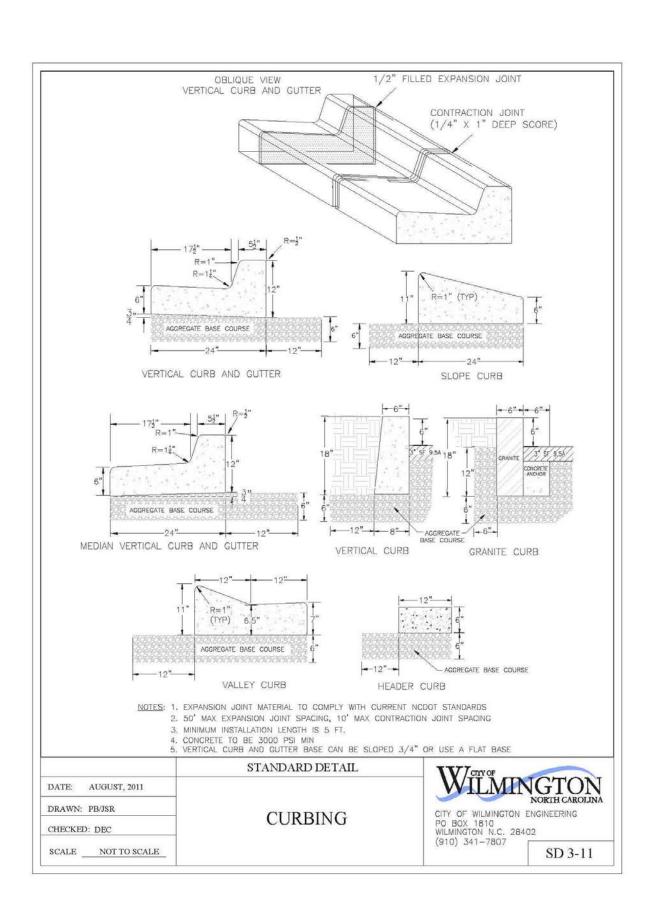
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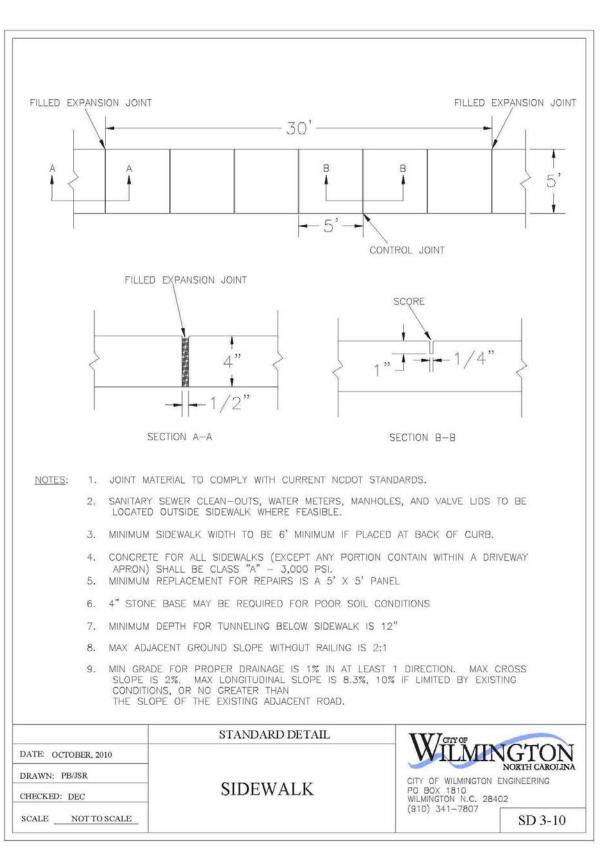
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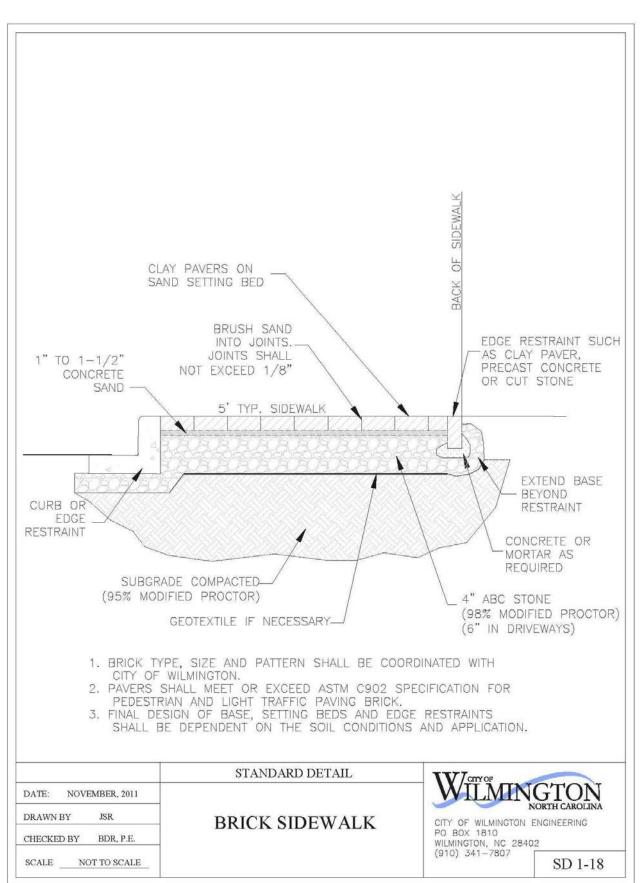
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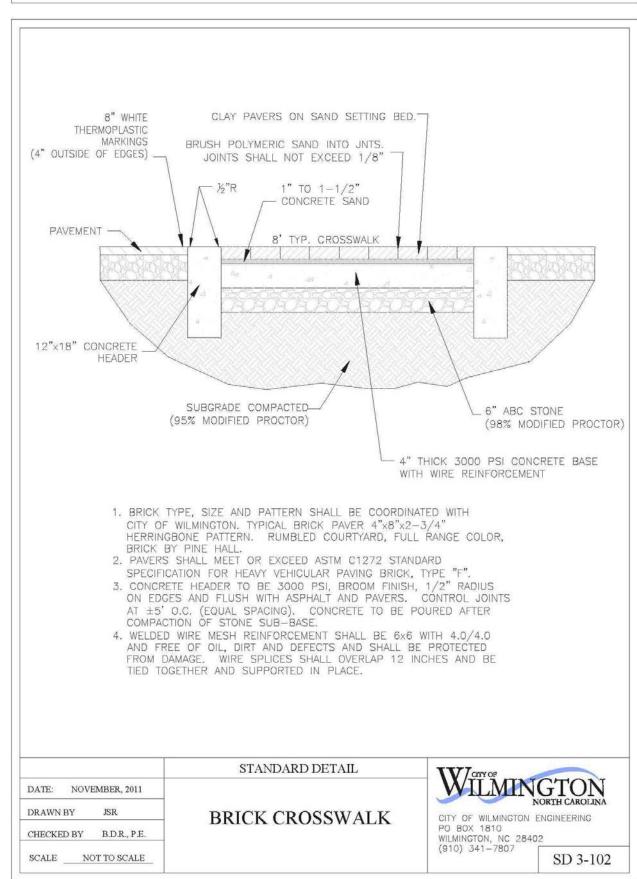



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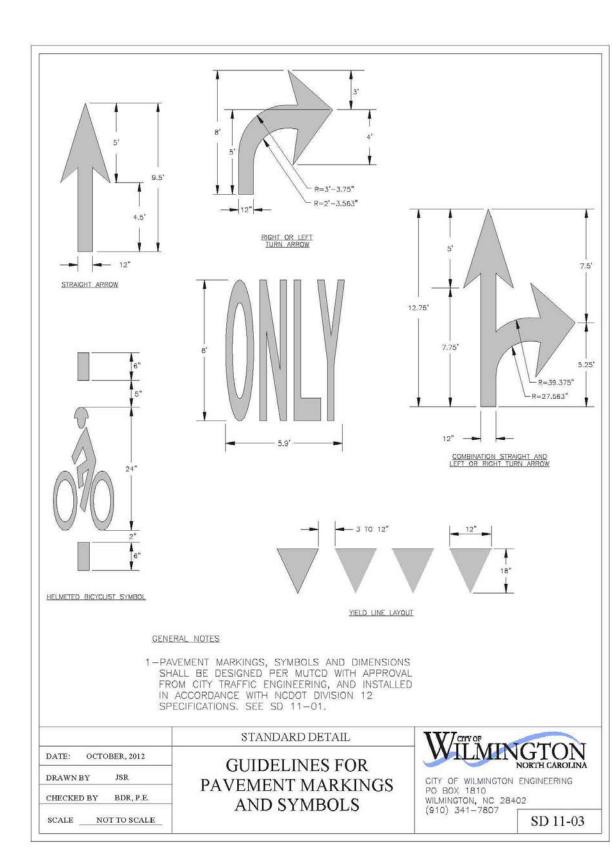











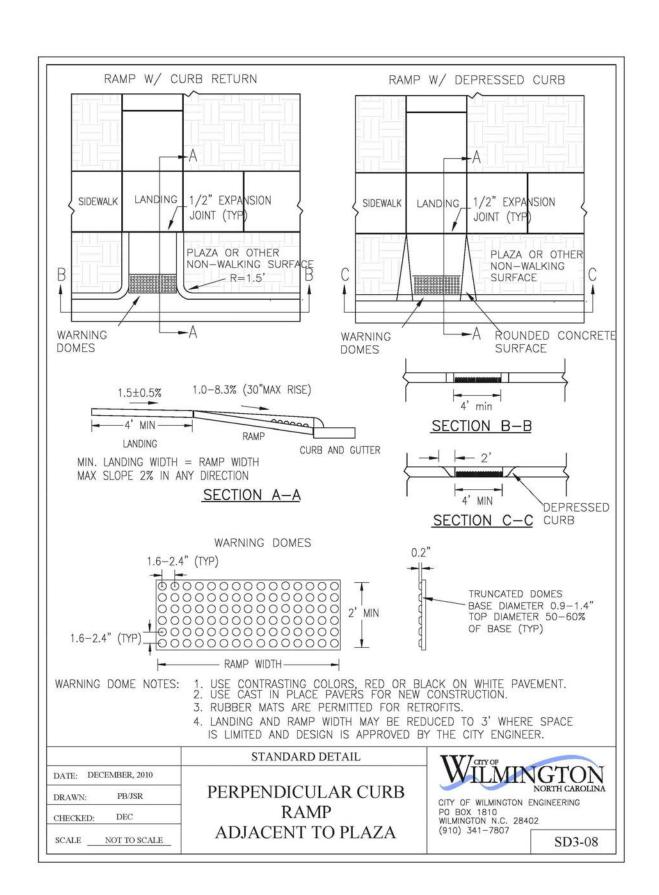

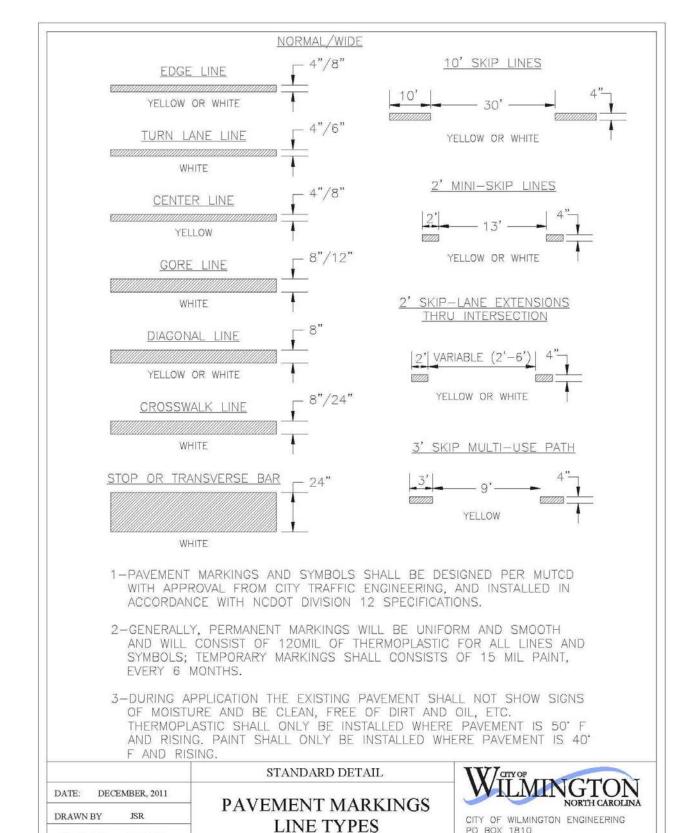

CHECKED BY BDR, P.E.

SCALE NOT TO SCALE

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PO BOX 1810 WILMINGTON, NC 28402

SD 11-01

(910) 341-7807

candDesign.

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ENGINEER REG. # DATE

DAVE & BUSTER'S
- MAYFAIRE

MAYFAIRE TOWN CENTER

WILMINGTON, NC

REVISION / ISSUANCE

NO. DESCRIPTION DATE

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DRAWN BY: RJK

CHECKED BY: RJK


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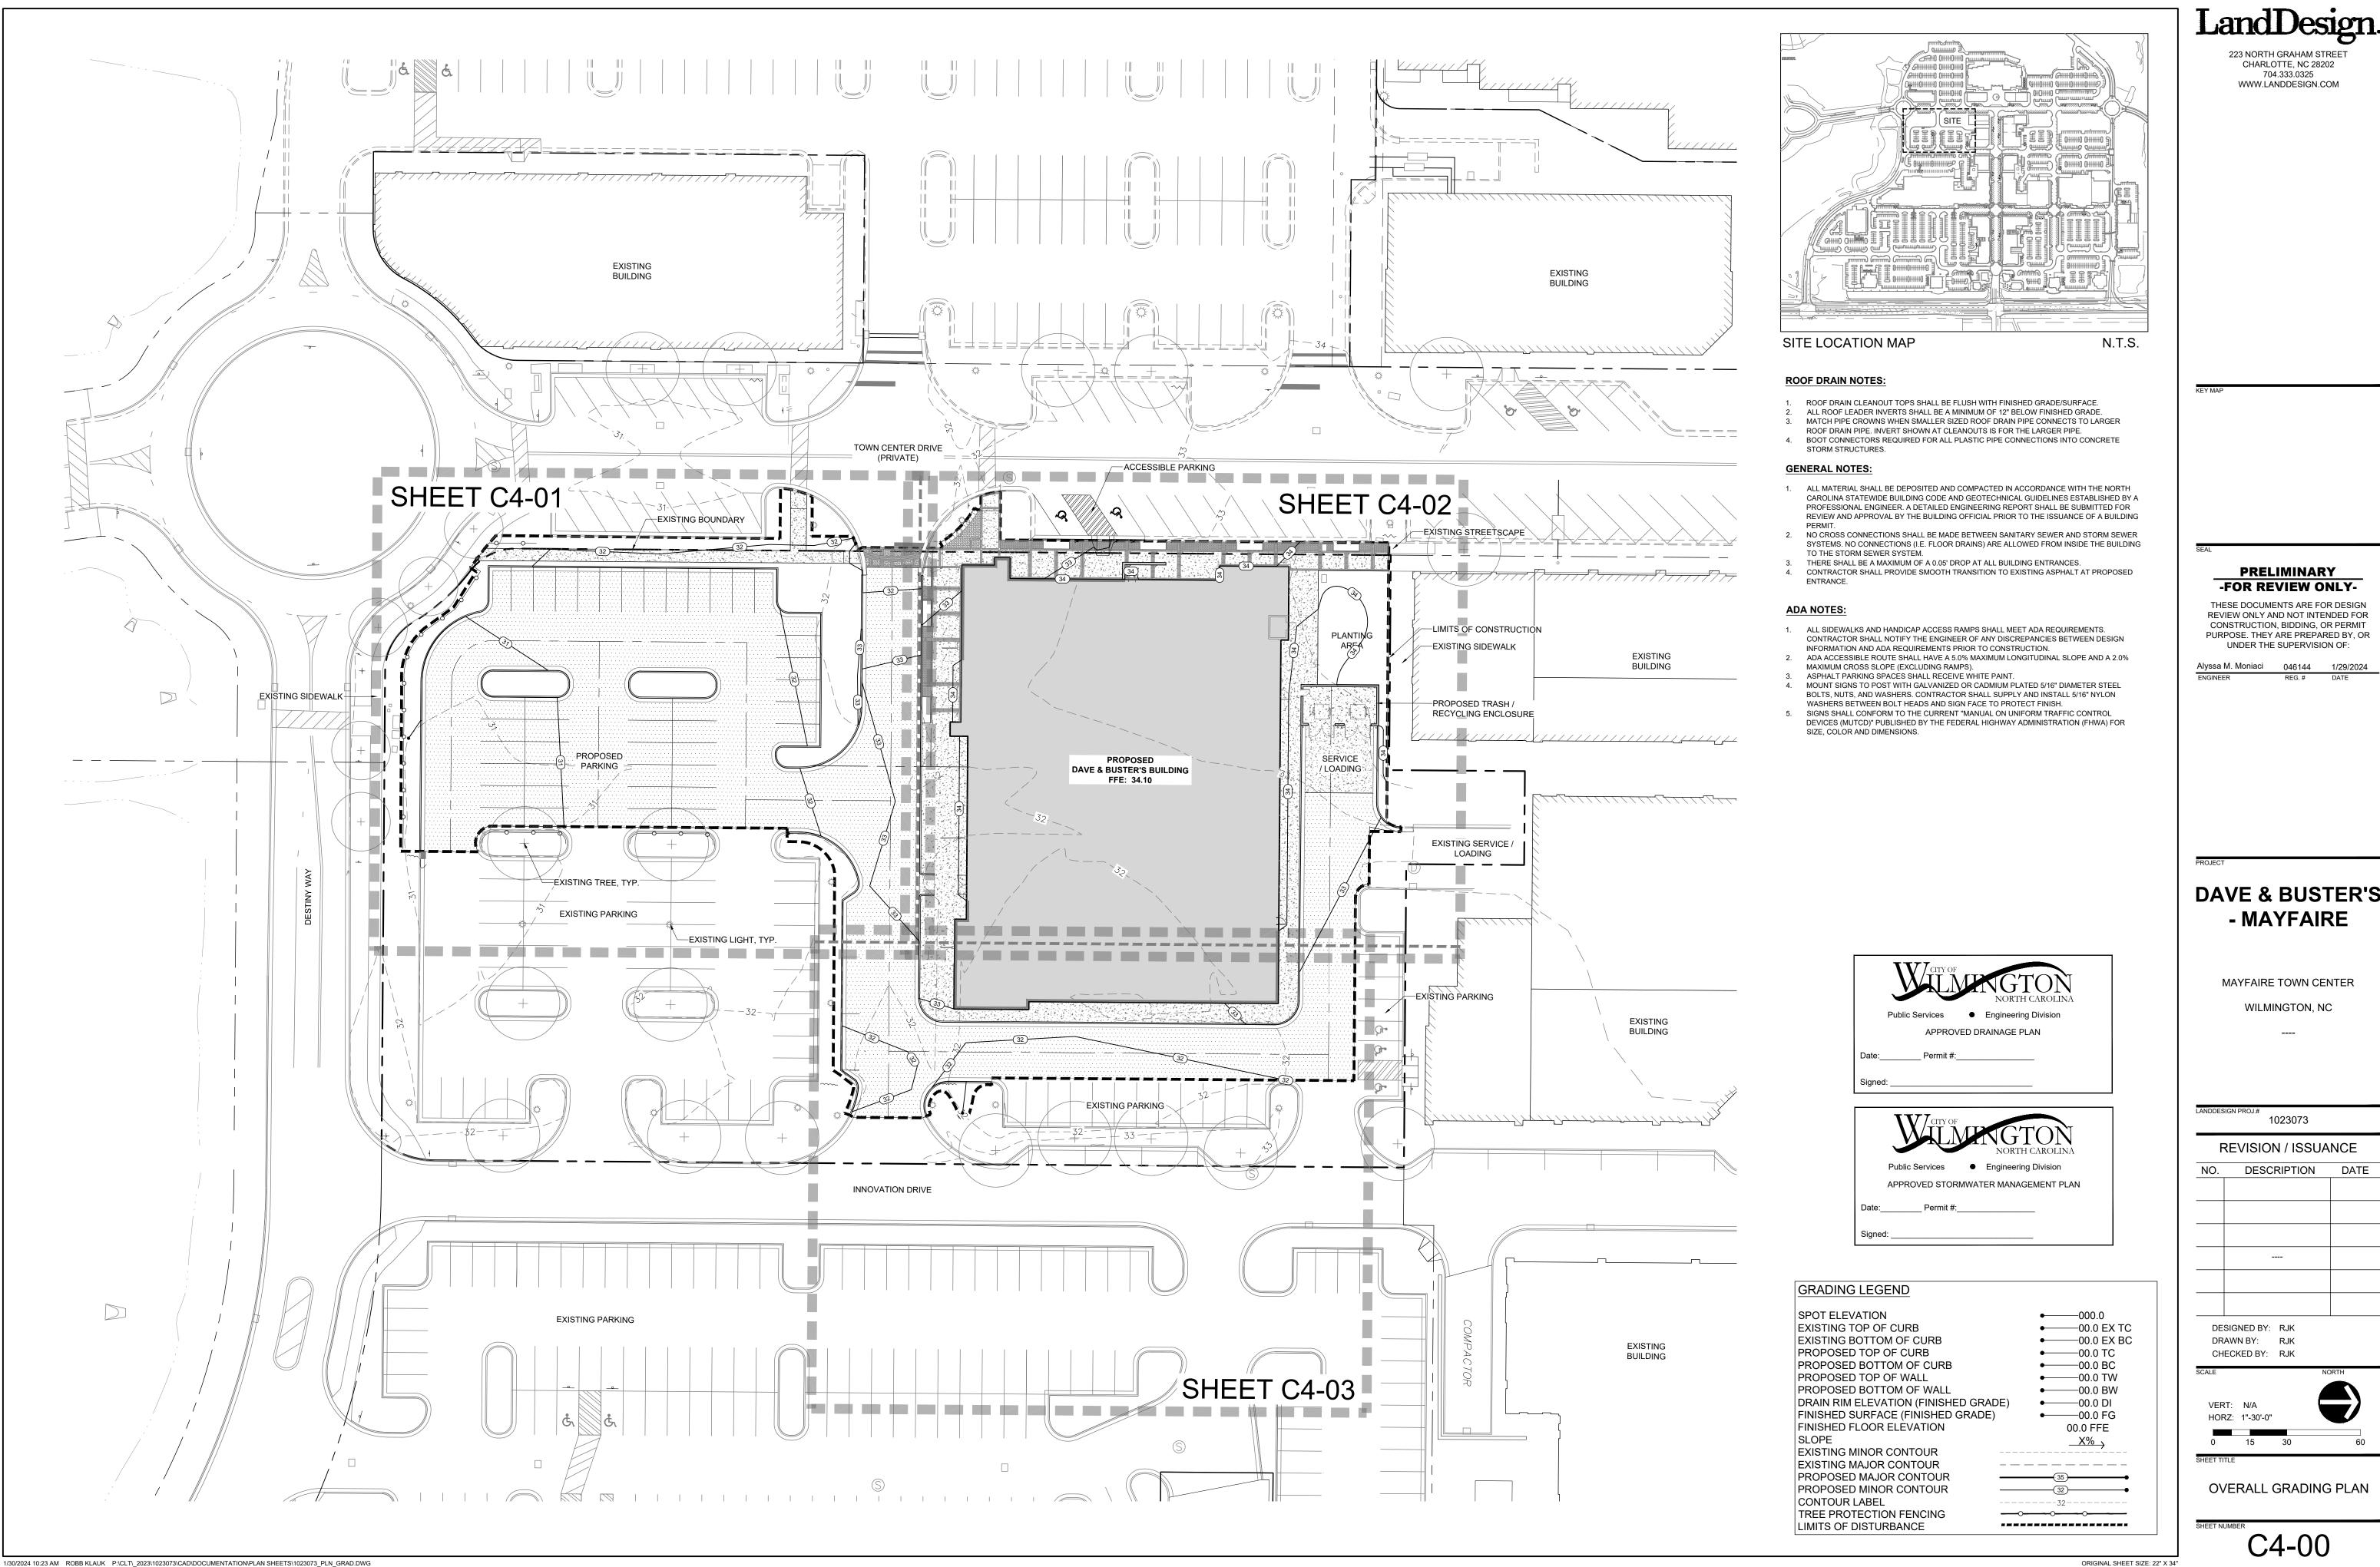
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ORIGINAL SHEET SIZE: 22" X 34"

SITE DETAILS

C3-03



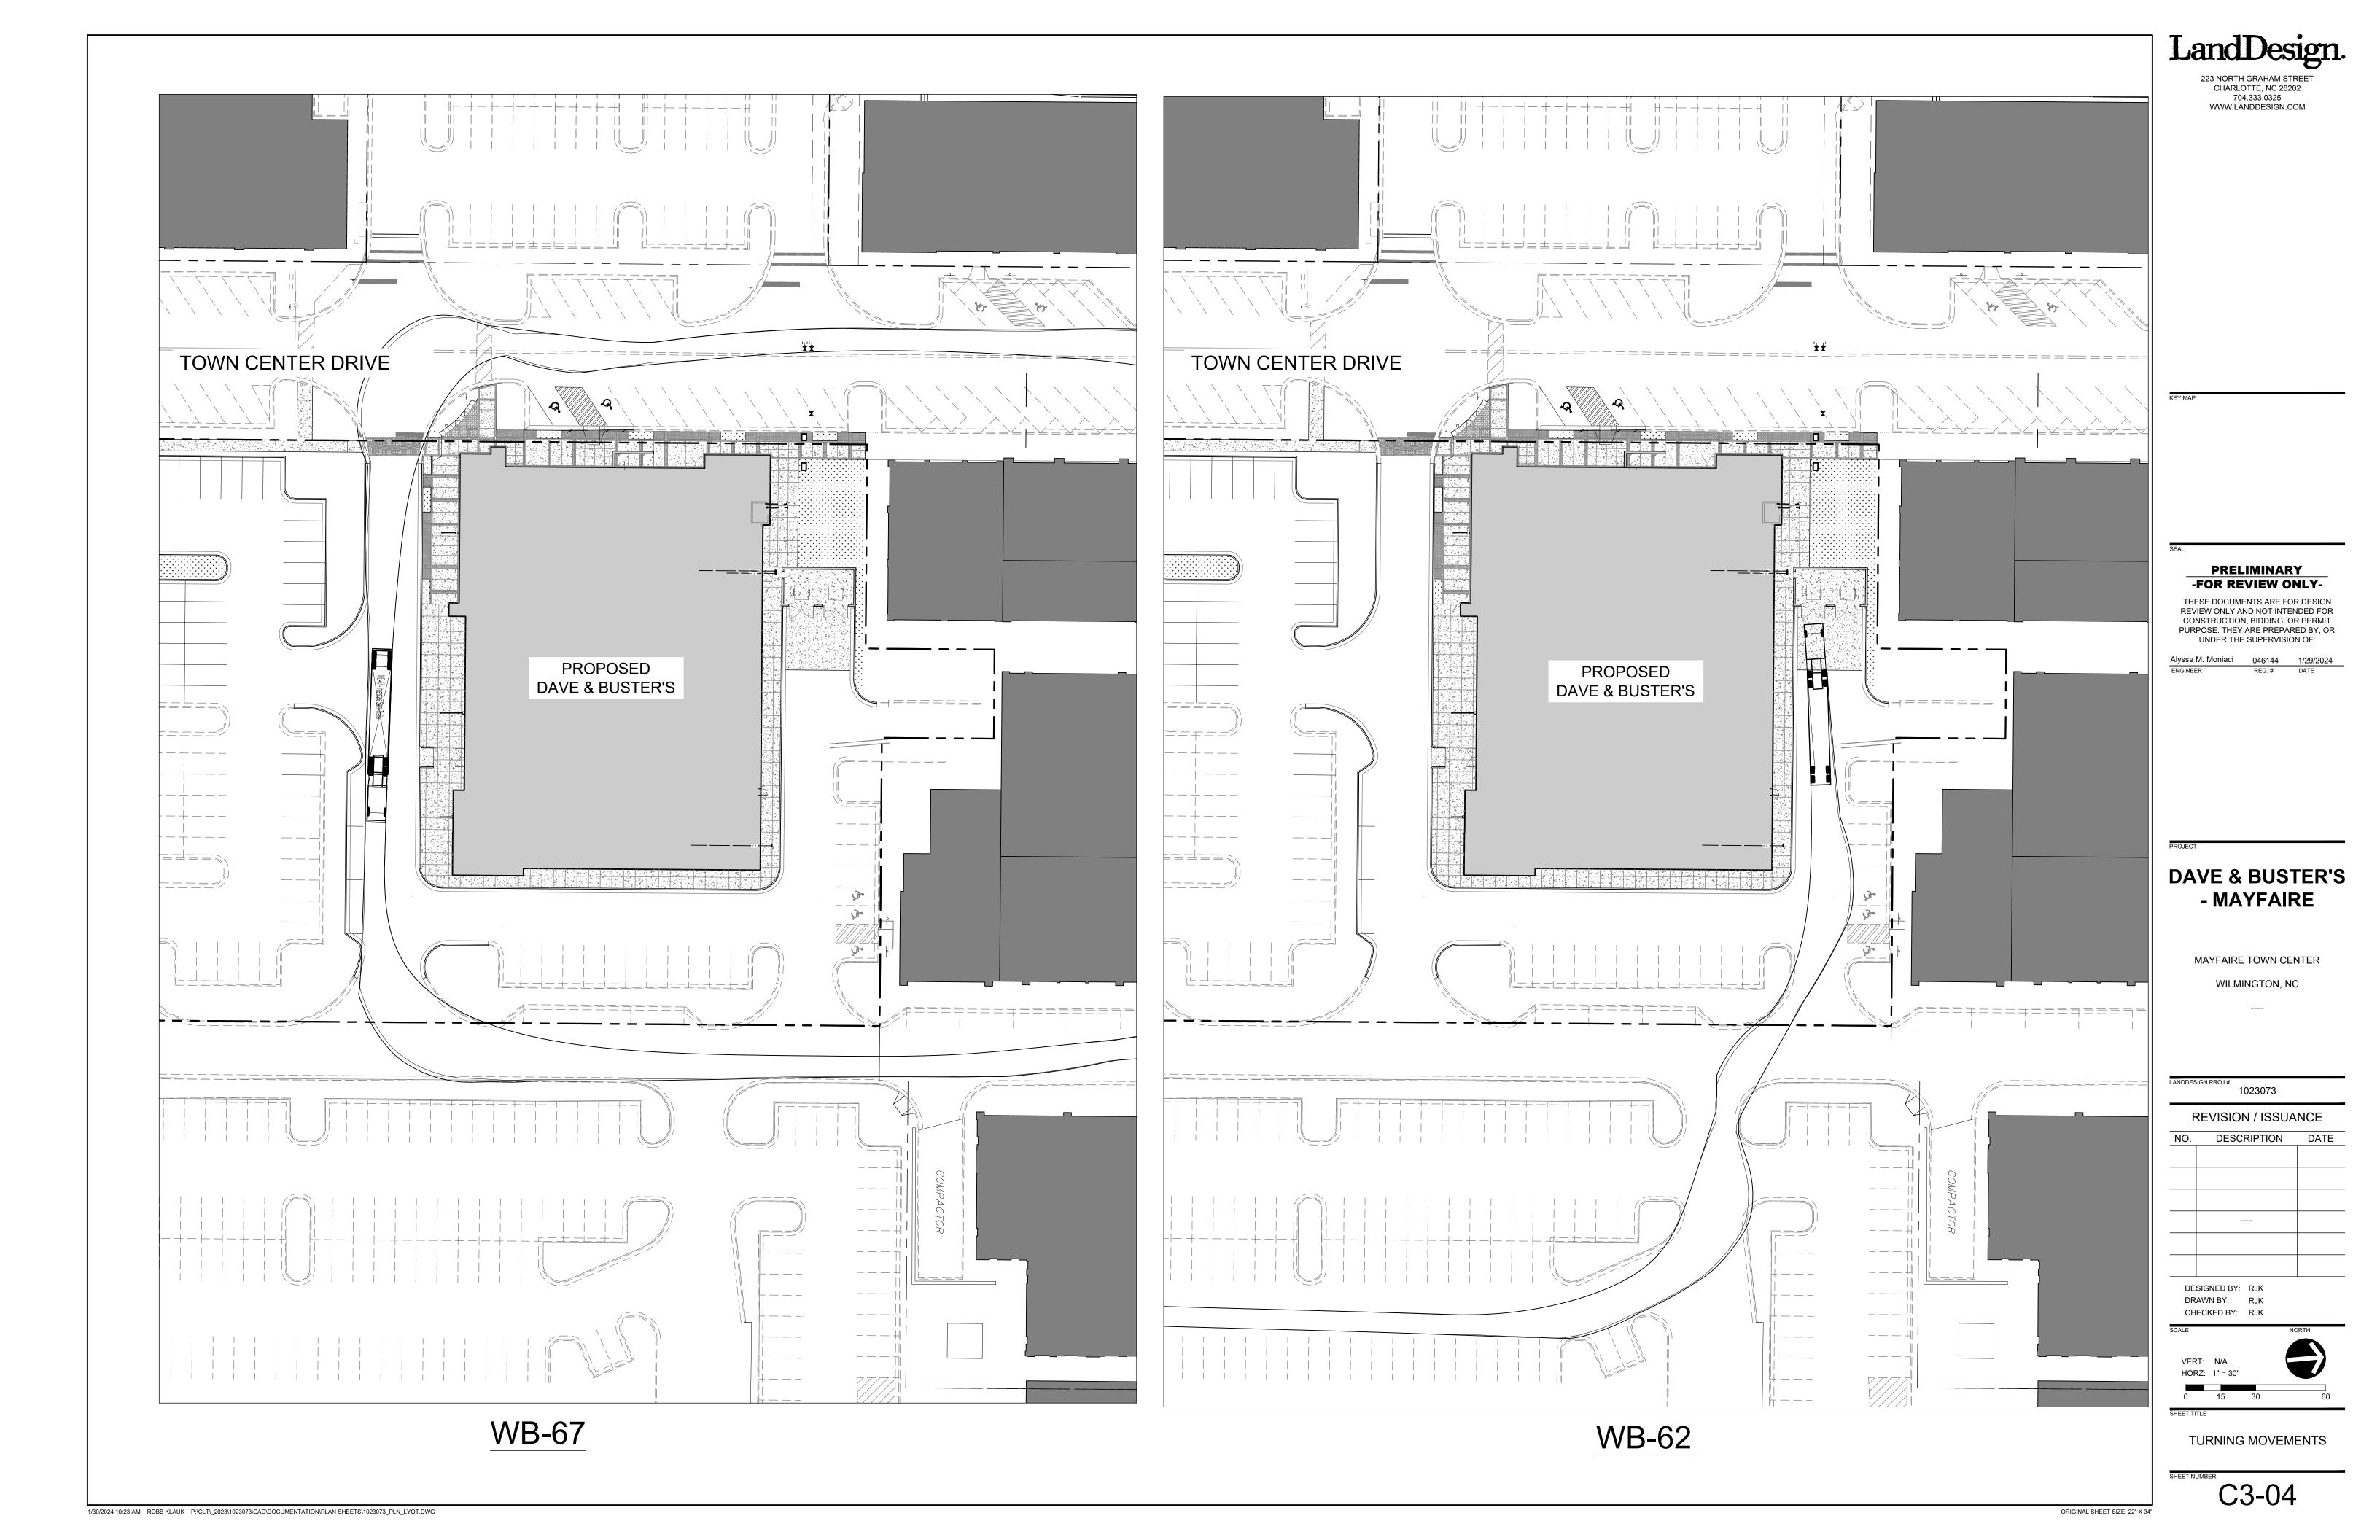

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DAVE & BUSTER'S - MAYFAIRE

MAYFAIRE TOWN CENTER

WILMINGTON, NC

1023073


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HORZ: 1"-30'-0"

OVERALL GRADING PLAN



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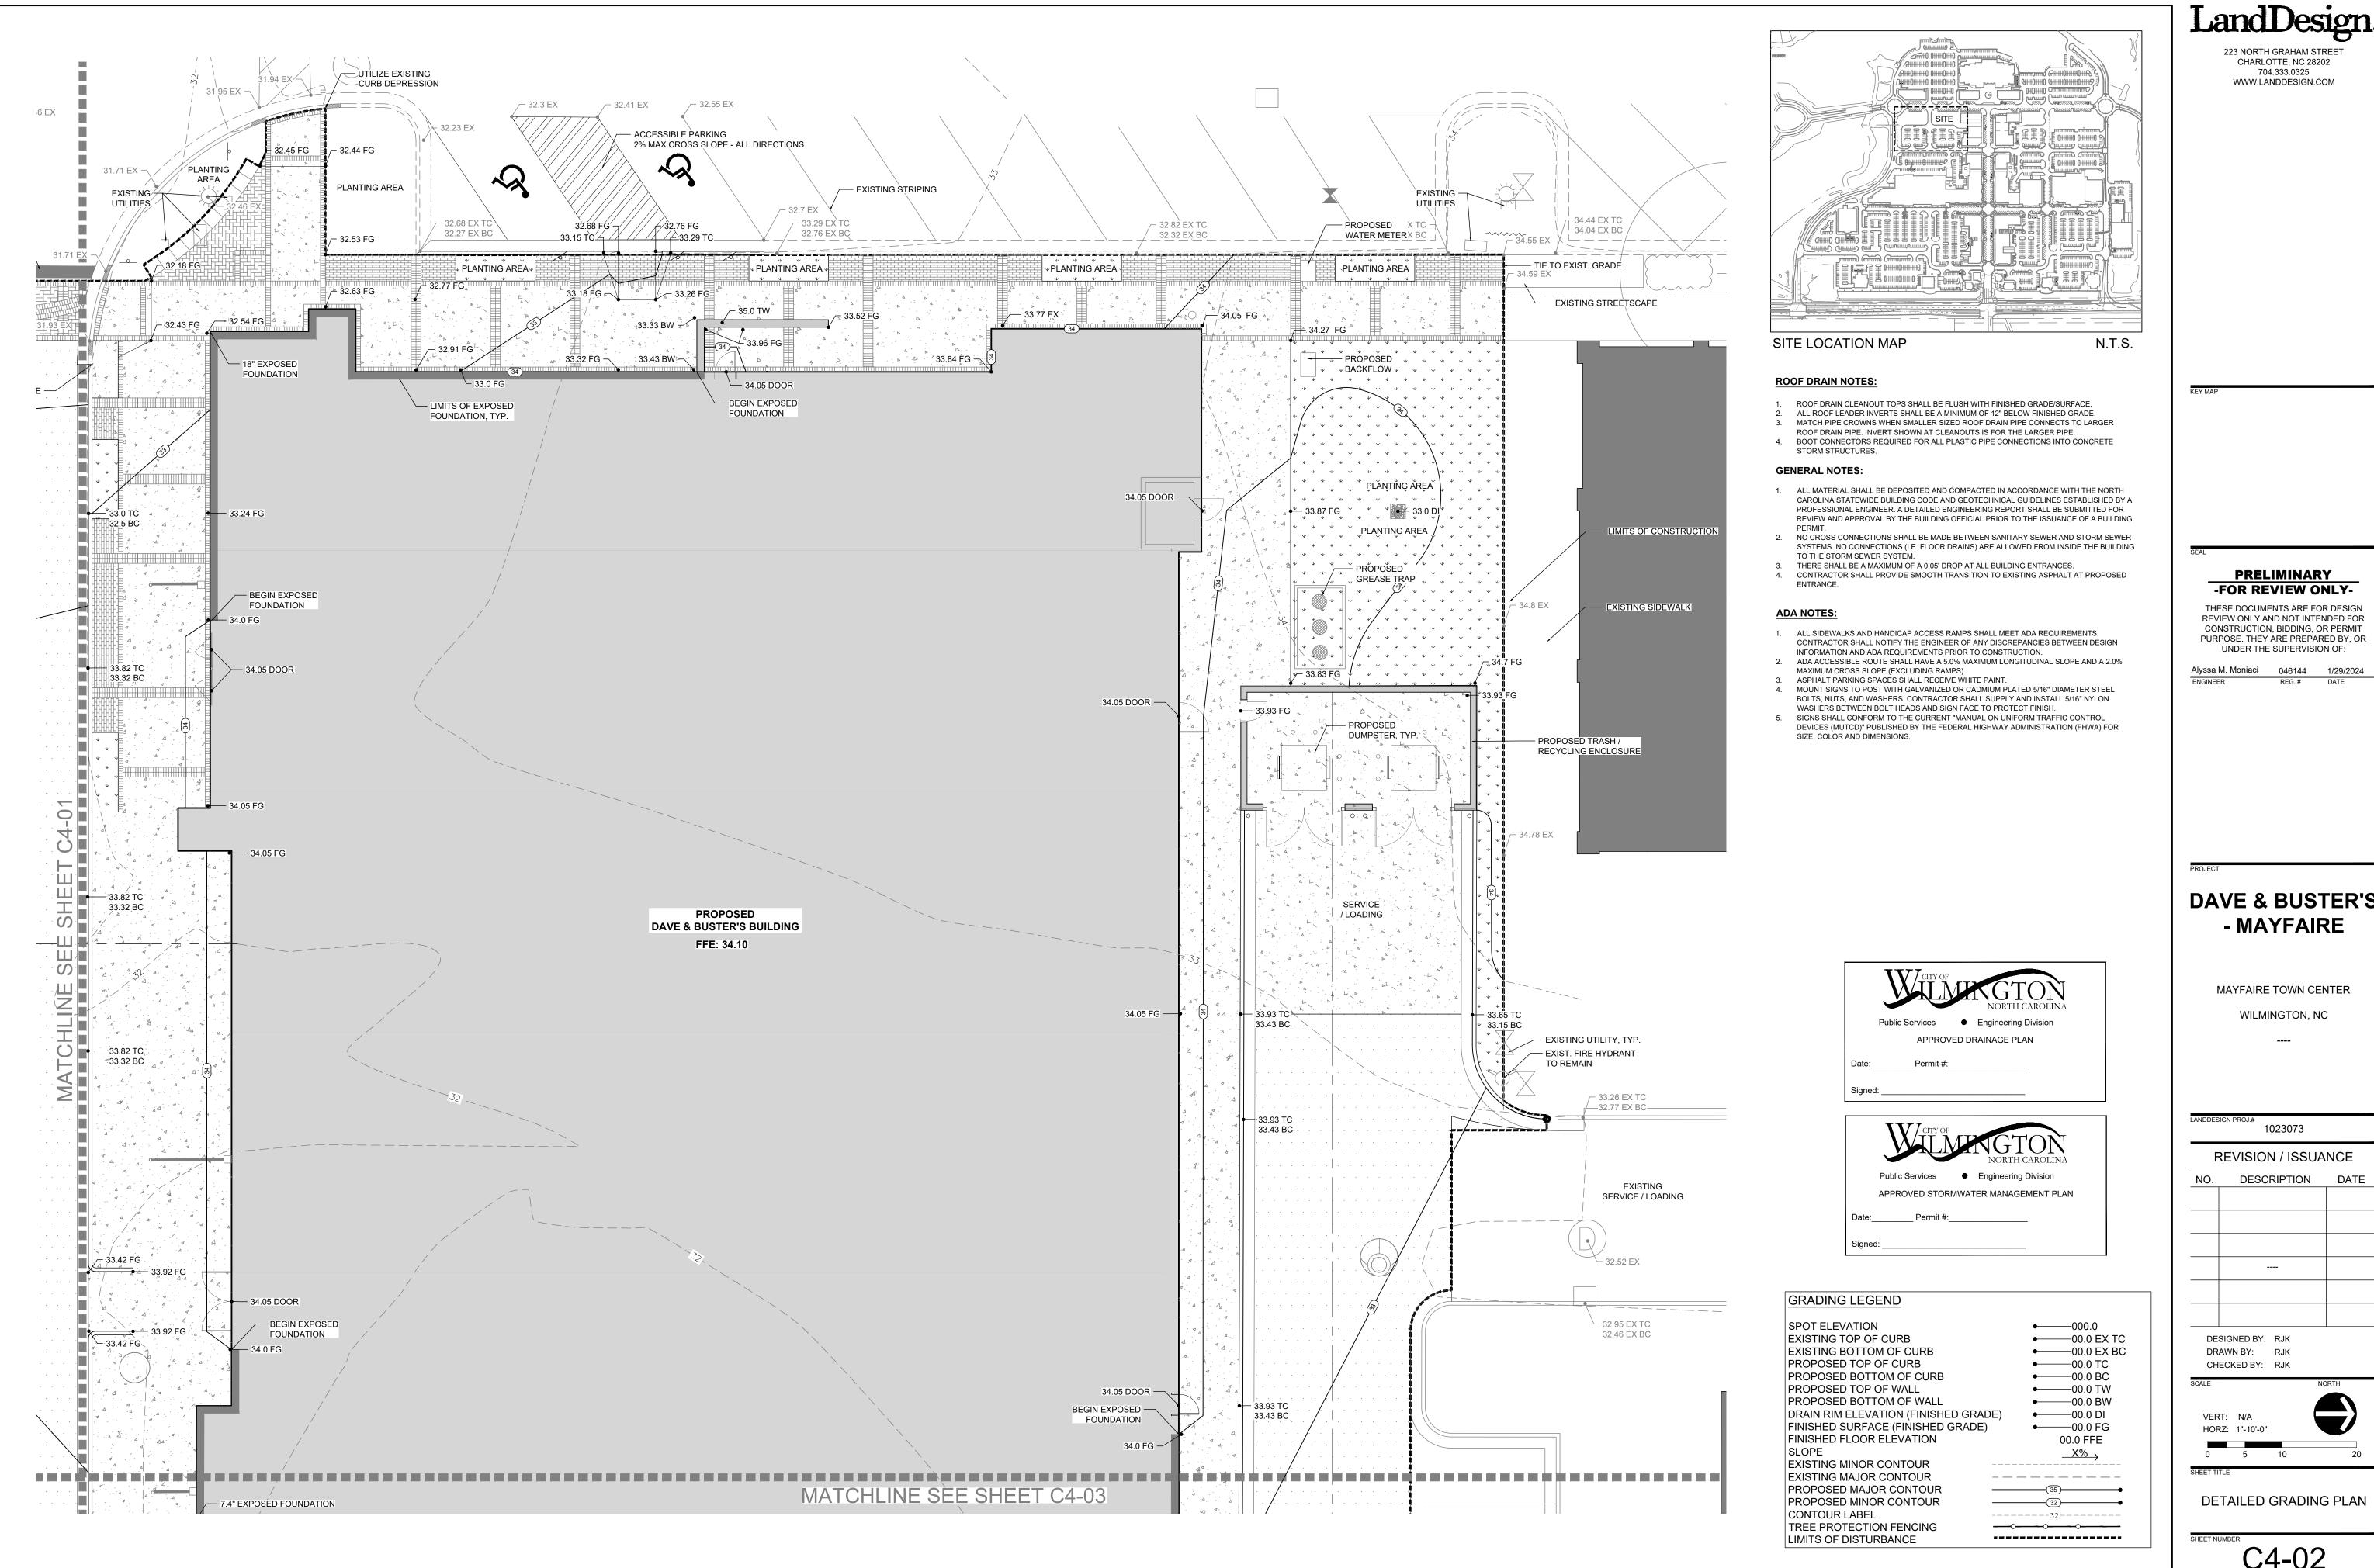
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ORIGINAL SHEET SIZE: 22" X 34"

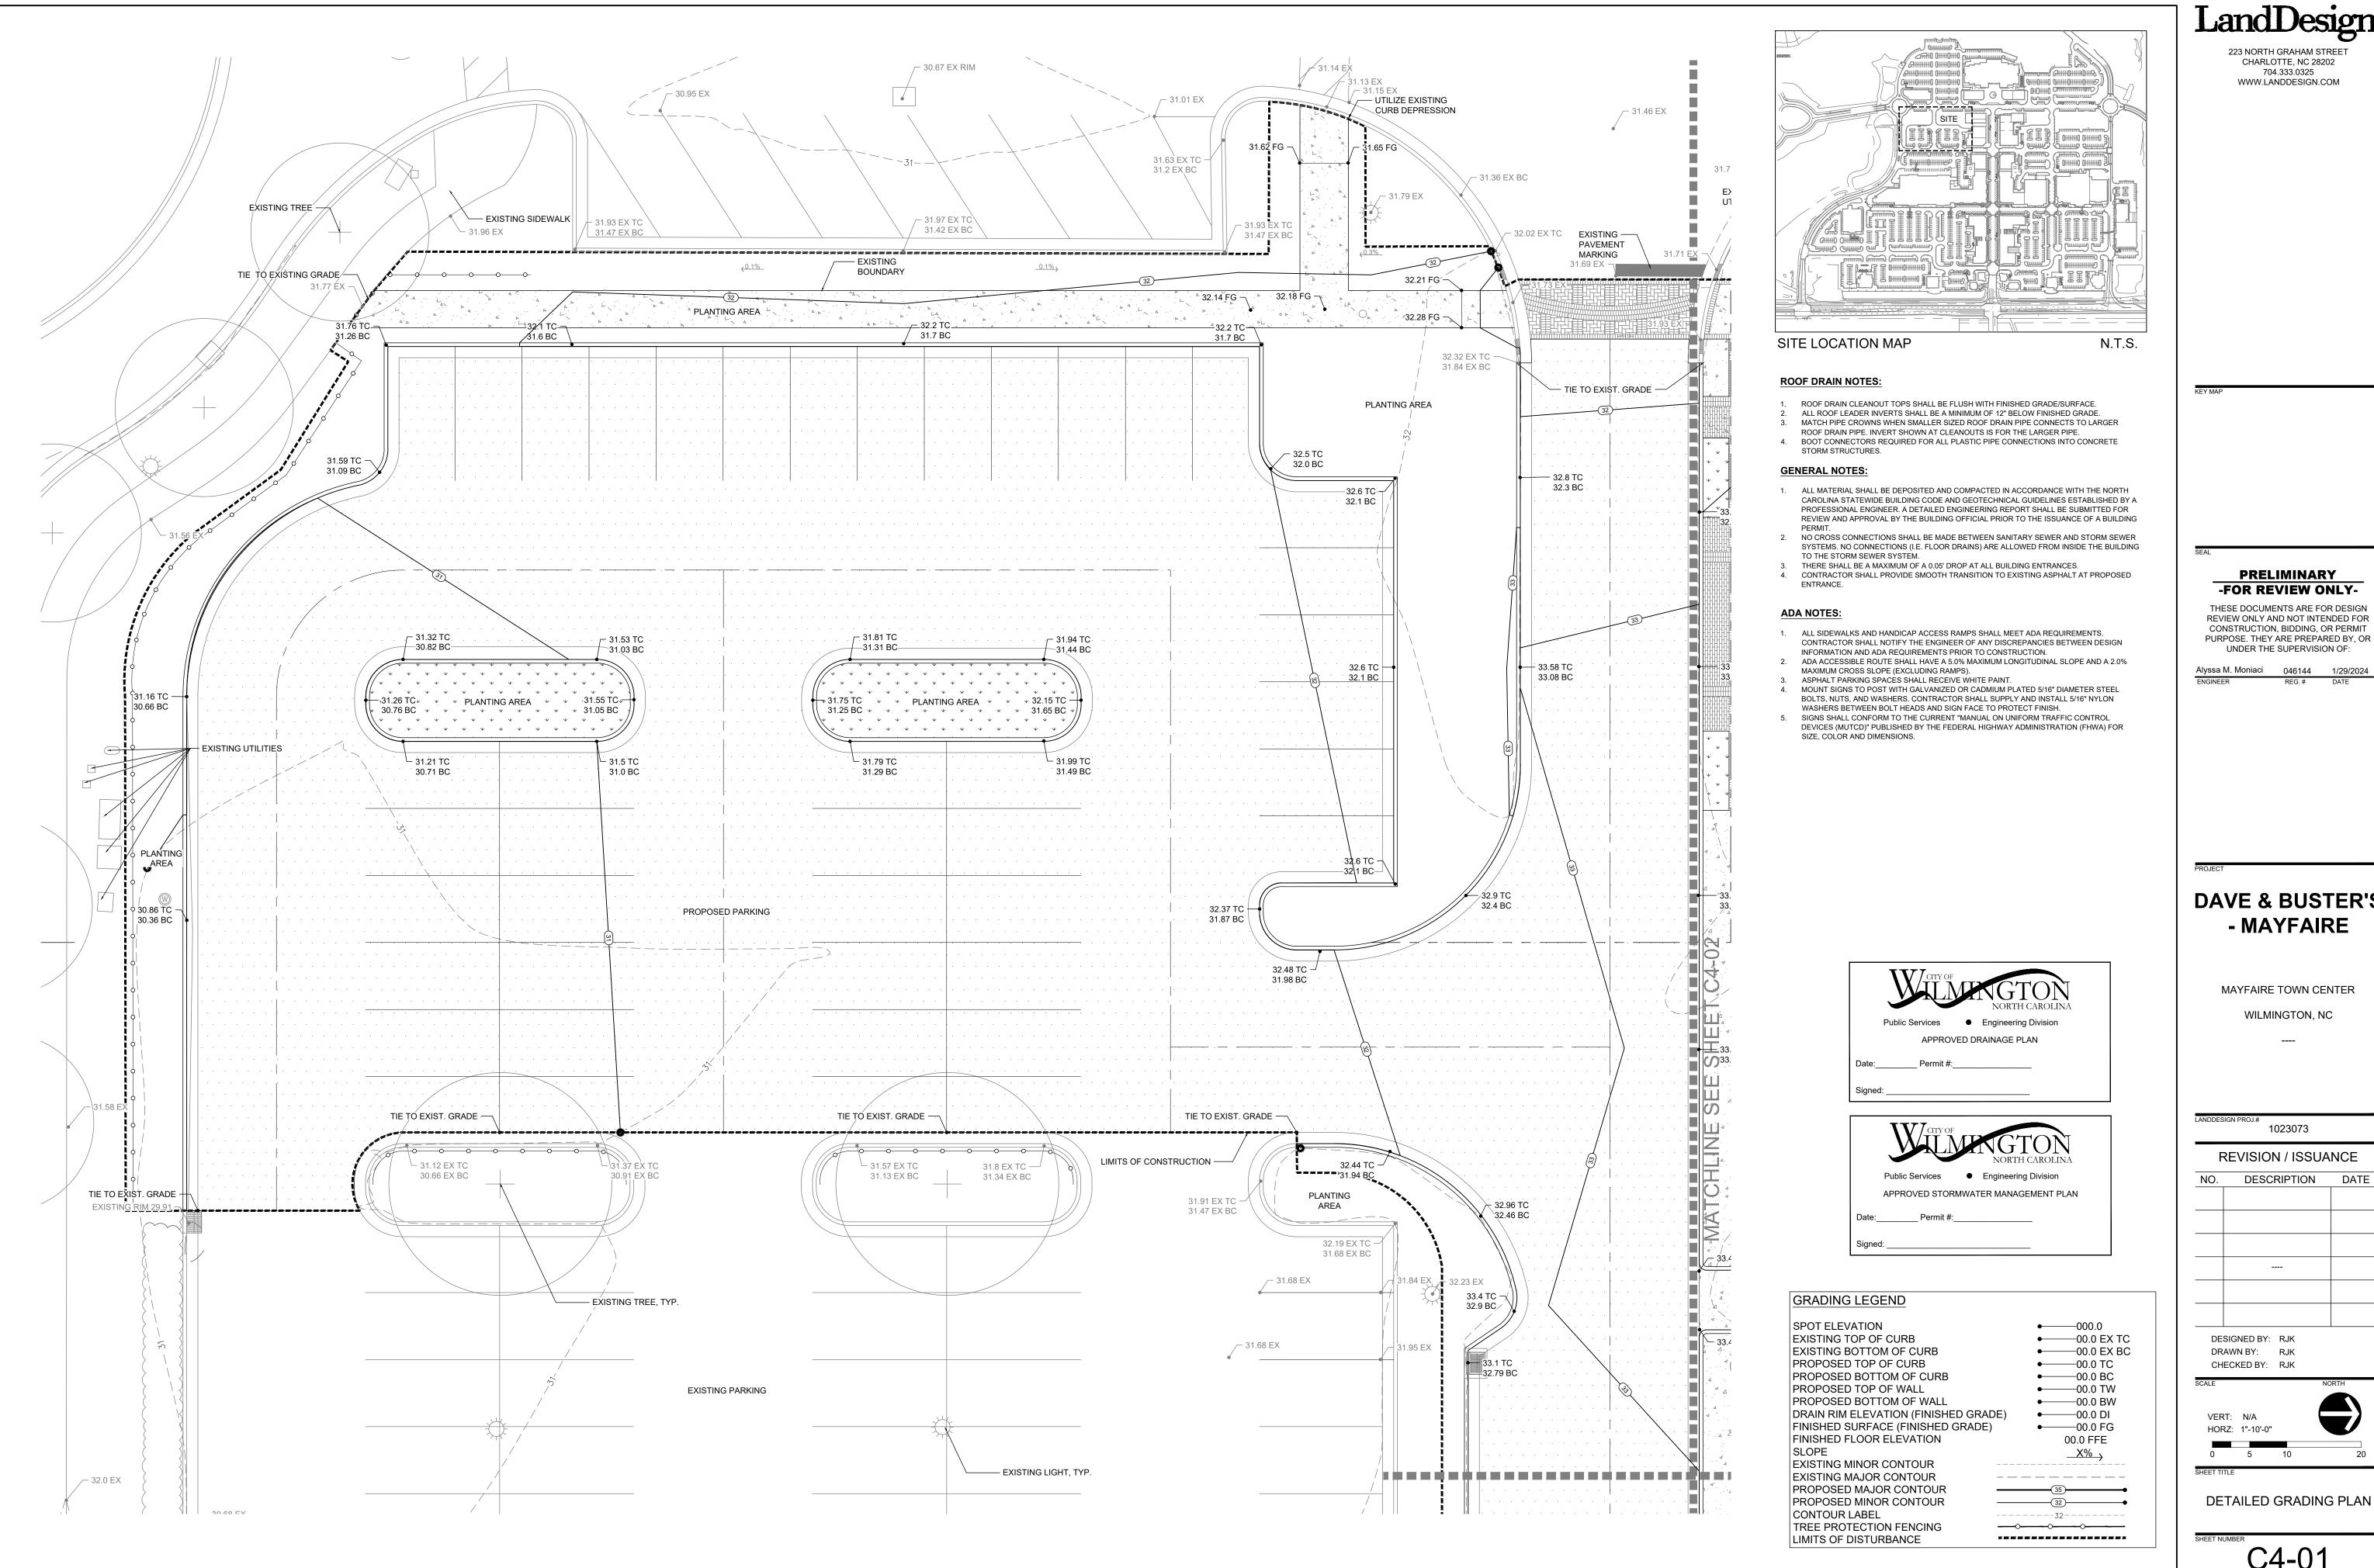

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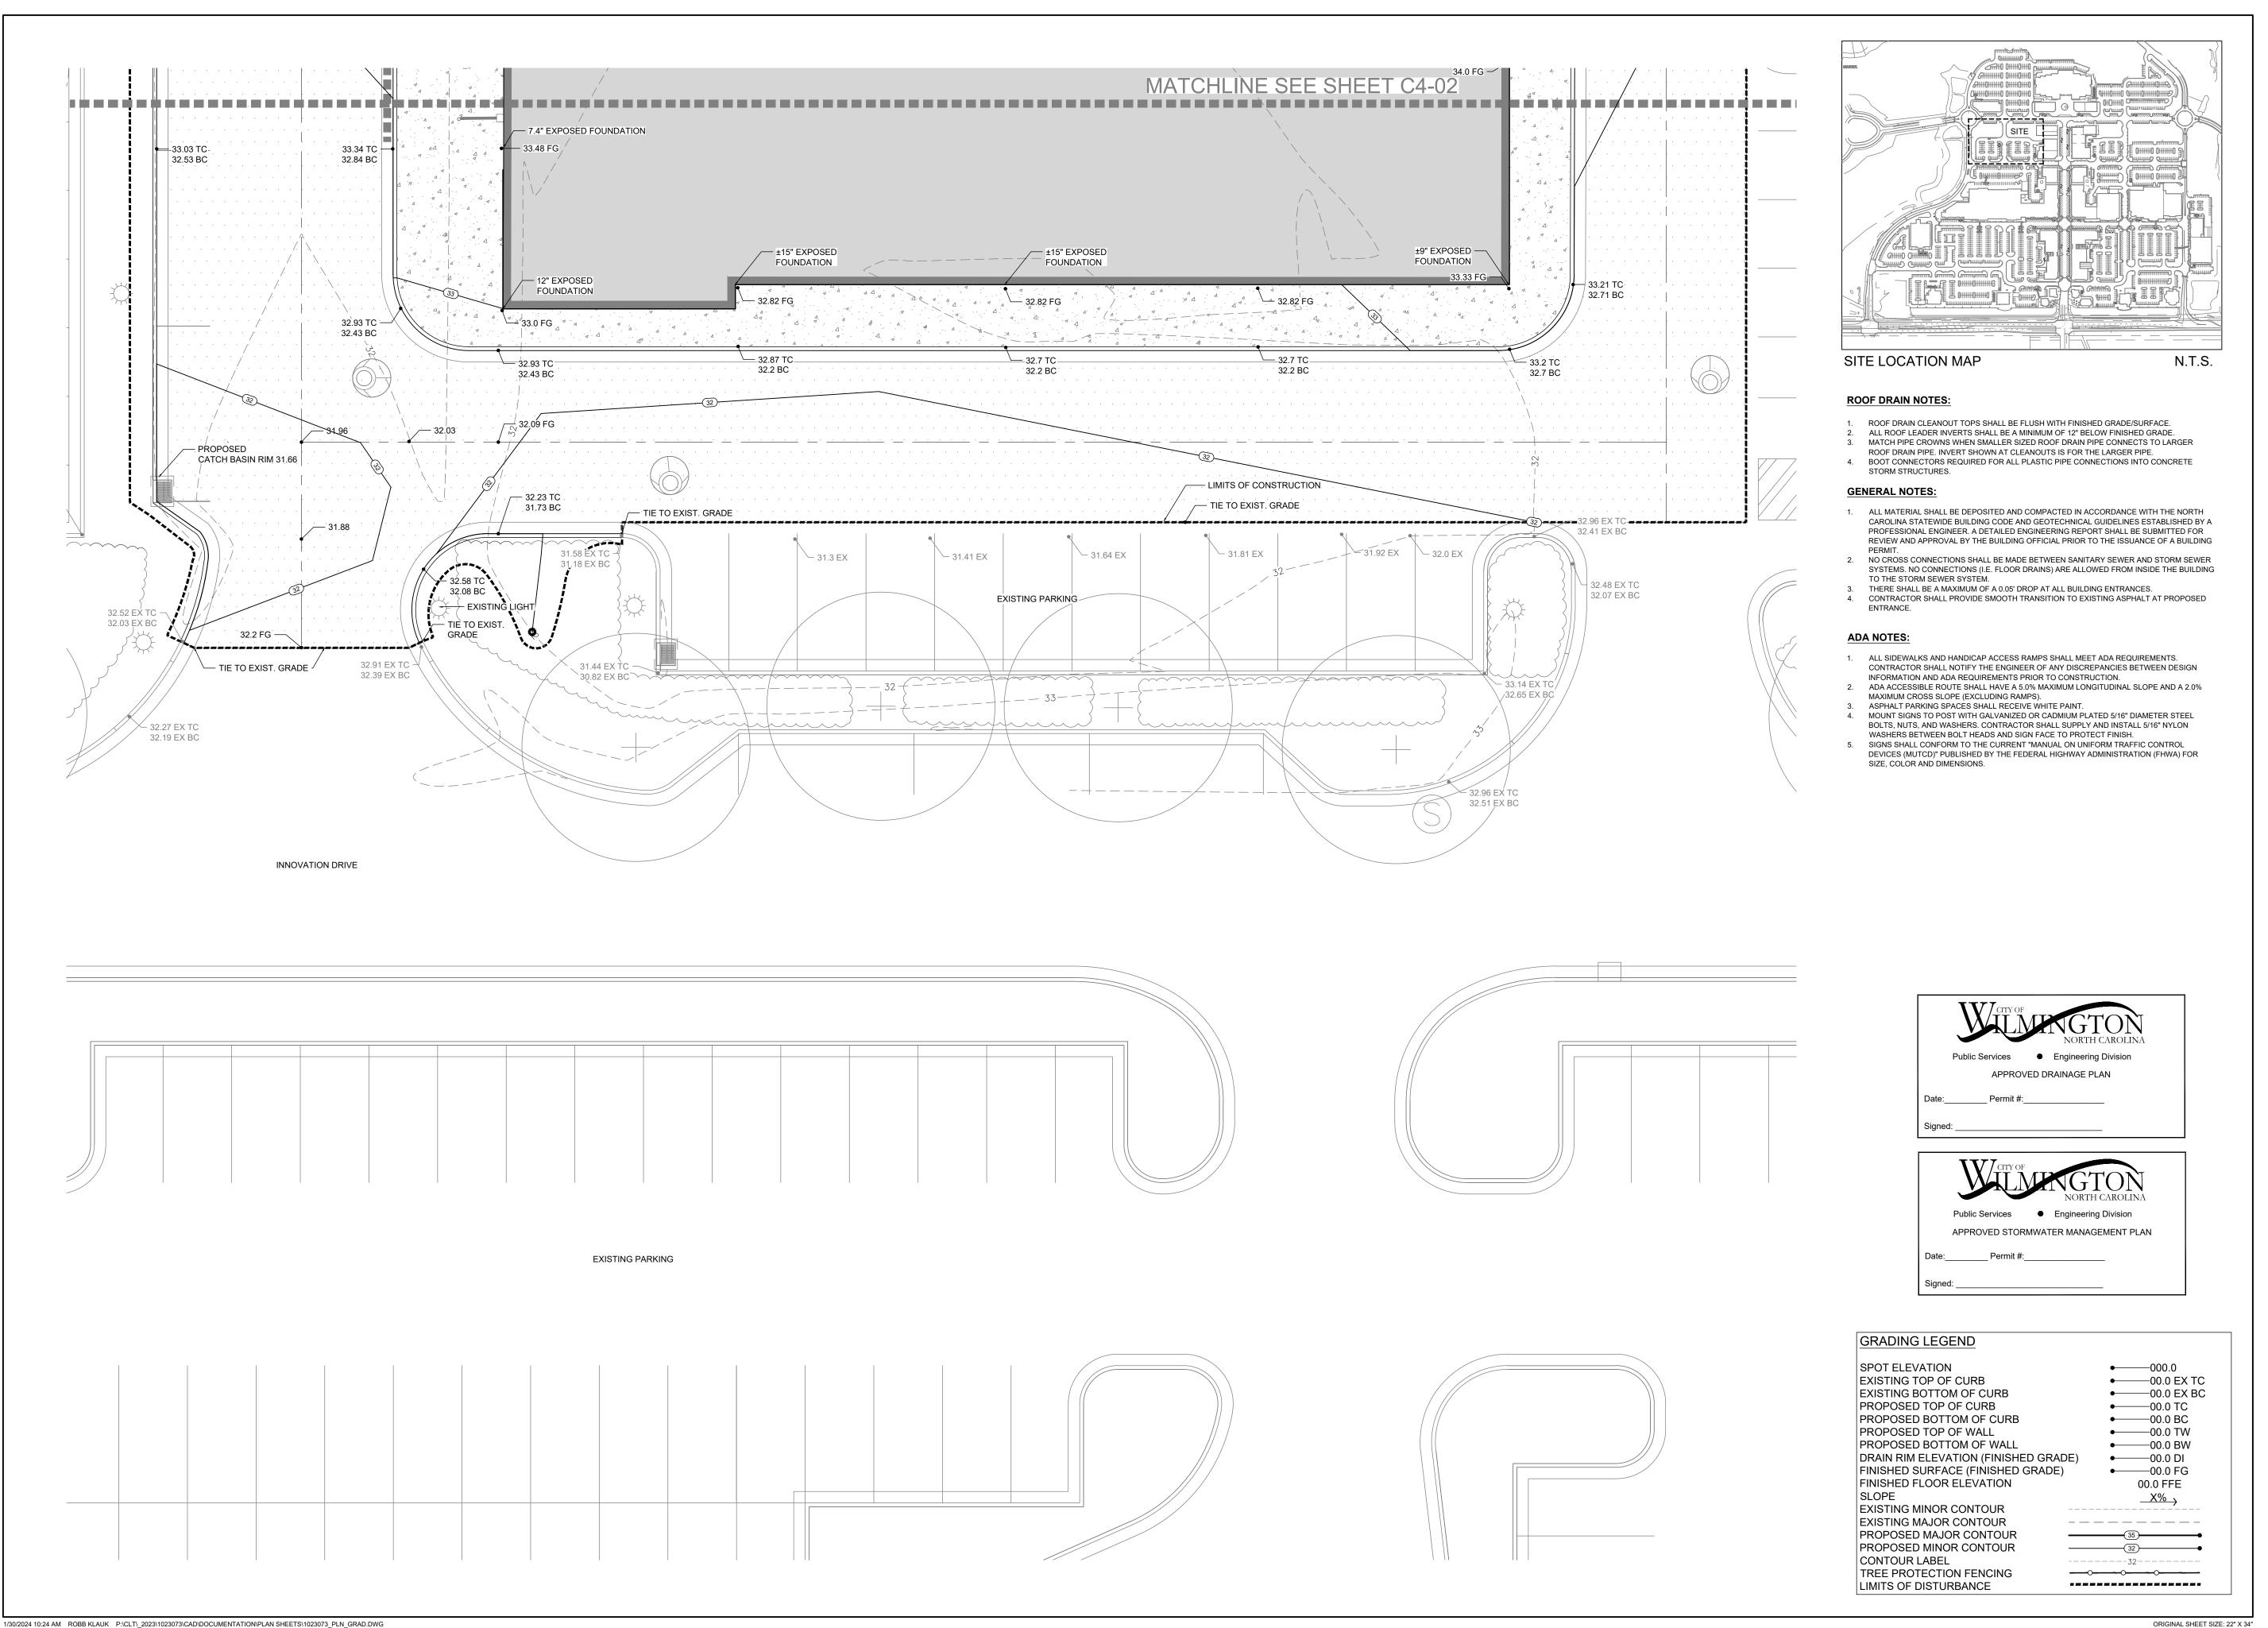
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HORZ: 1"-10'-0"

ORIGINAL SHEET SIZE: 22" X 34"

DETAILED GRADING PLAN



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DAVE & BUSTER'S
- MAYFAIRE

MAYFAIRE TOWN CENTER

WILMINGTON, NC

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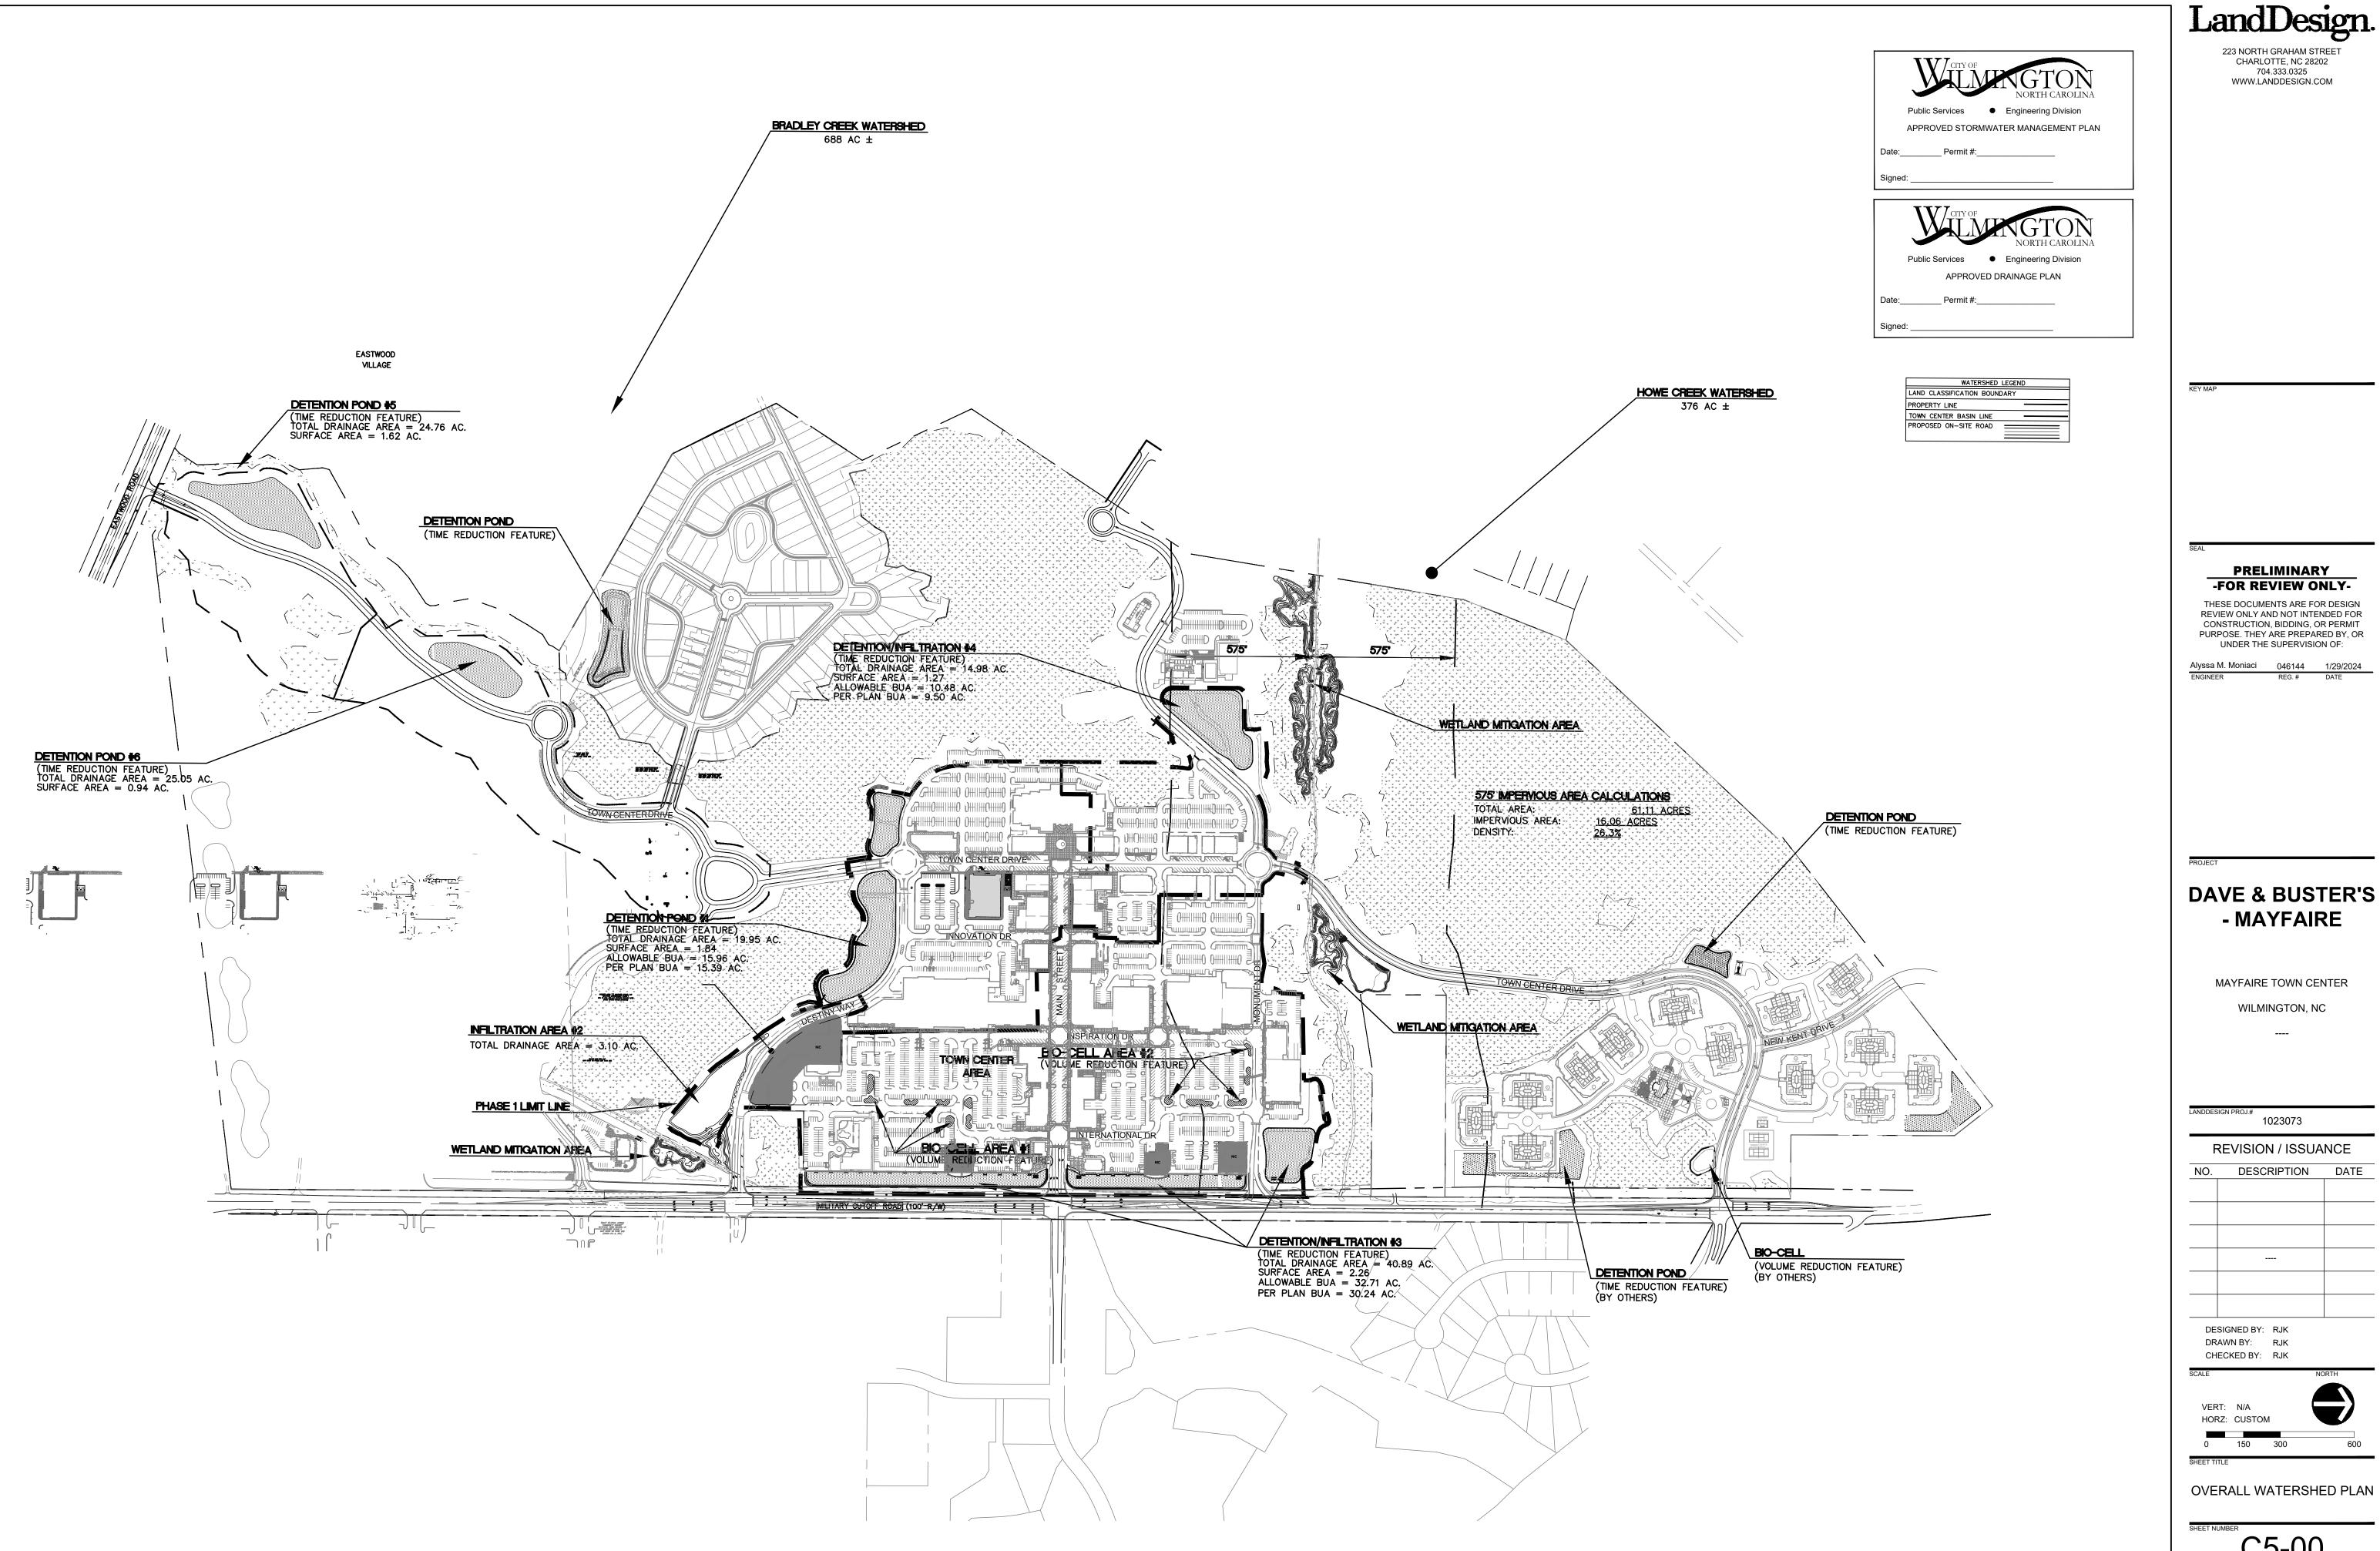
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DETAILED GRADING PLAN




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- MAYFAIRE

MAYFAIRE TOWN CENTER

WILMINGTON, NC

1023073
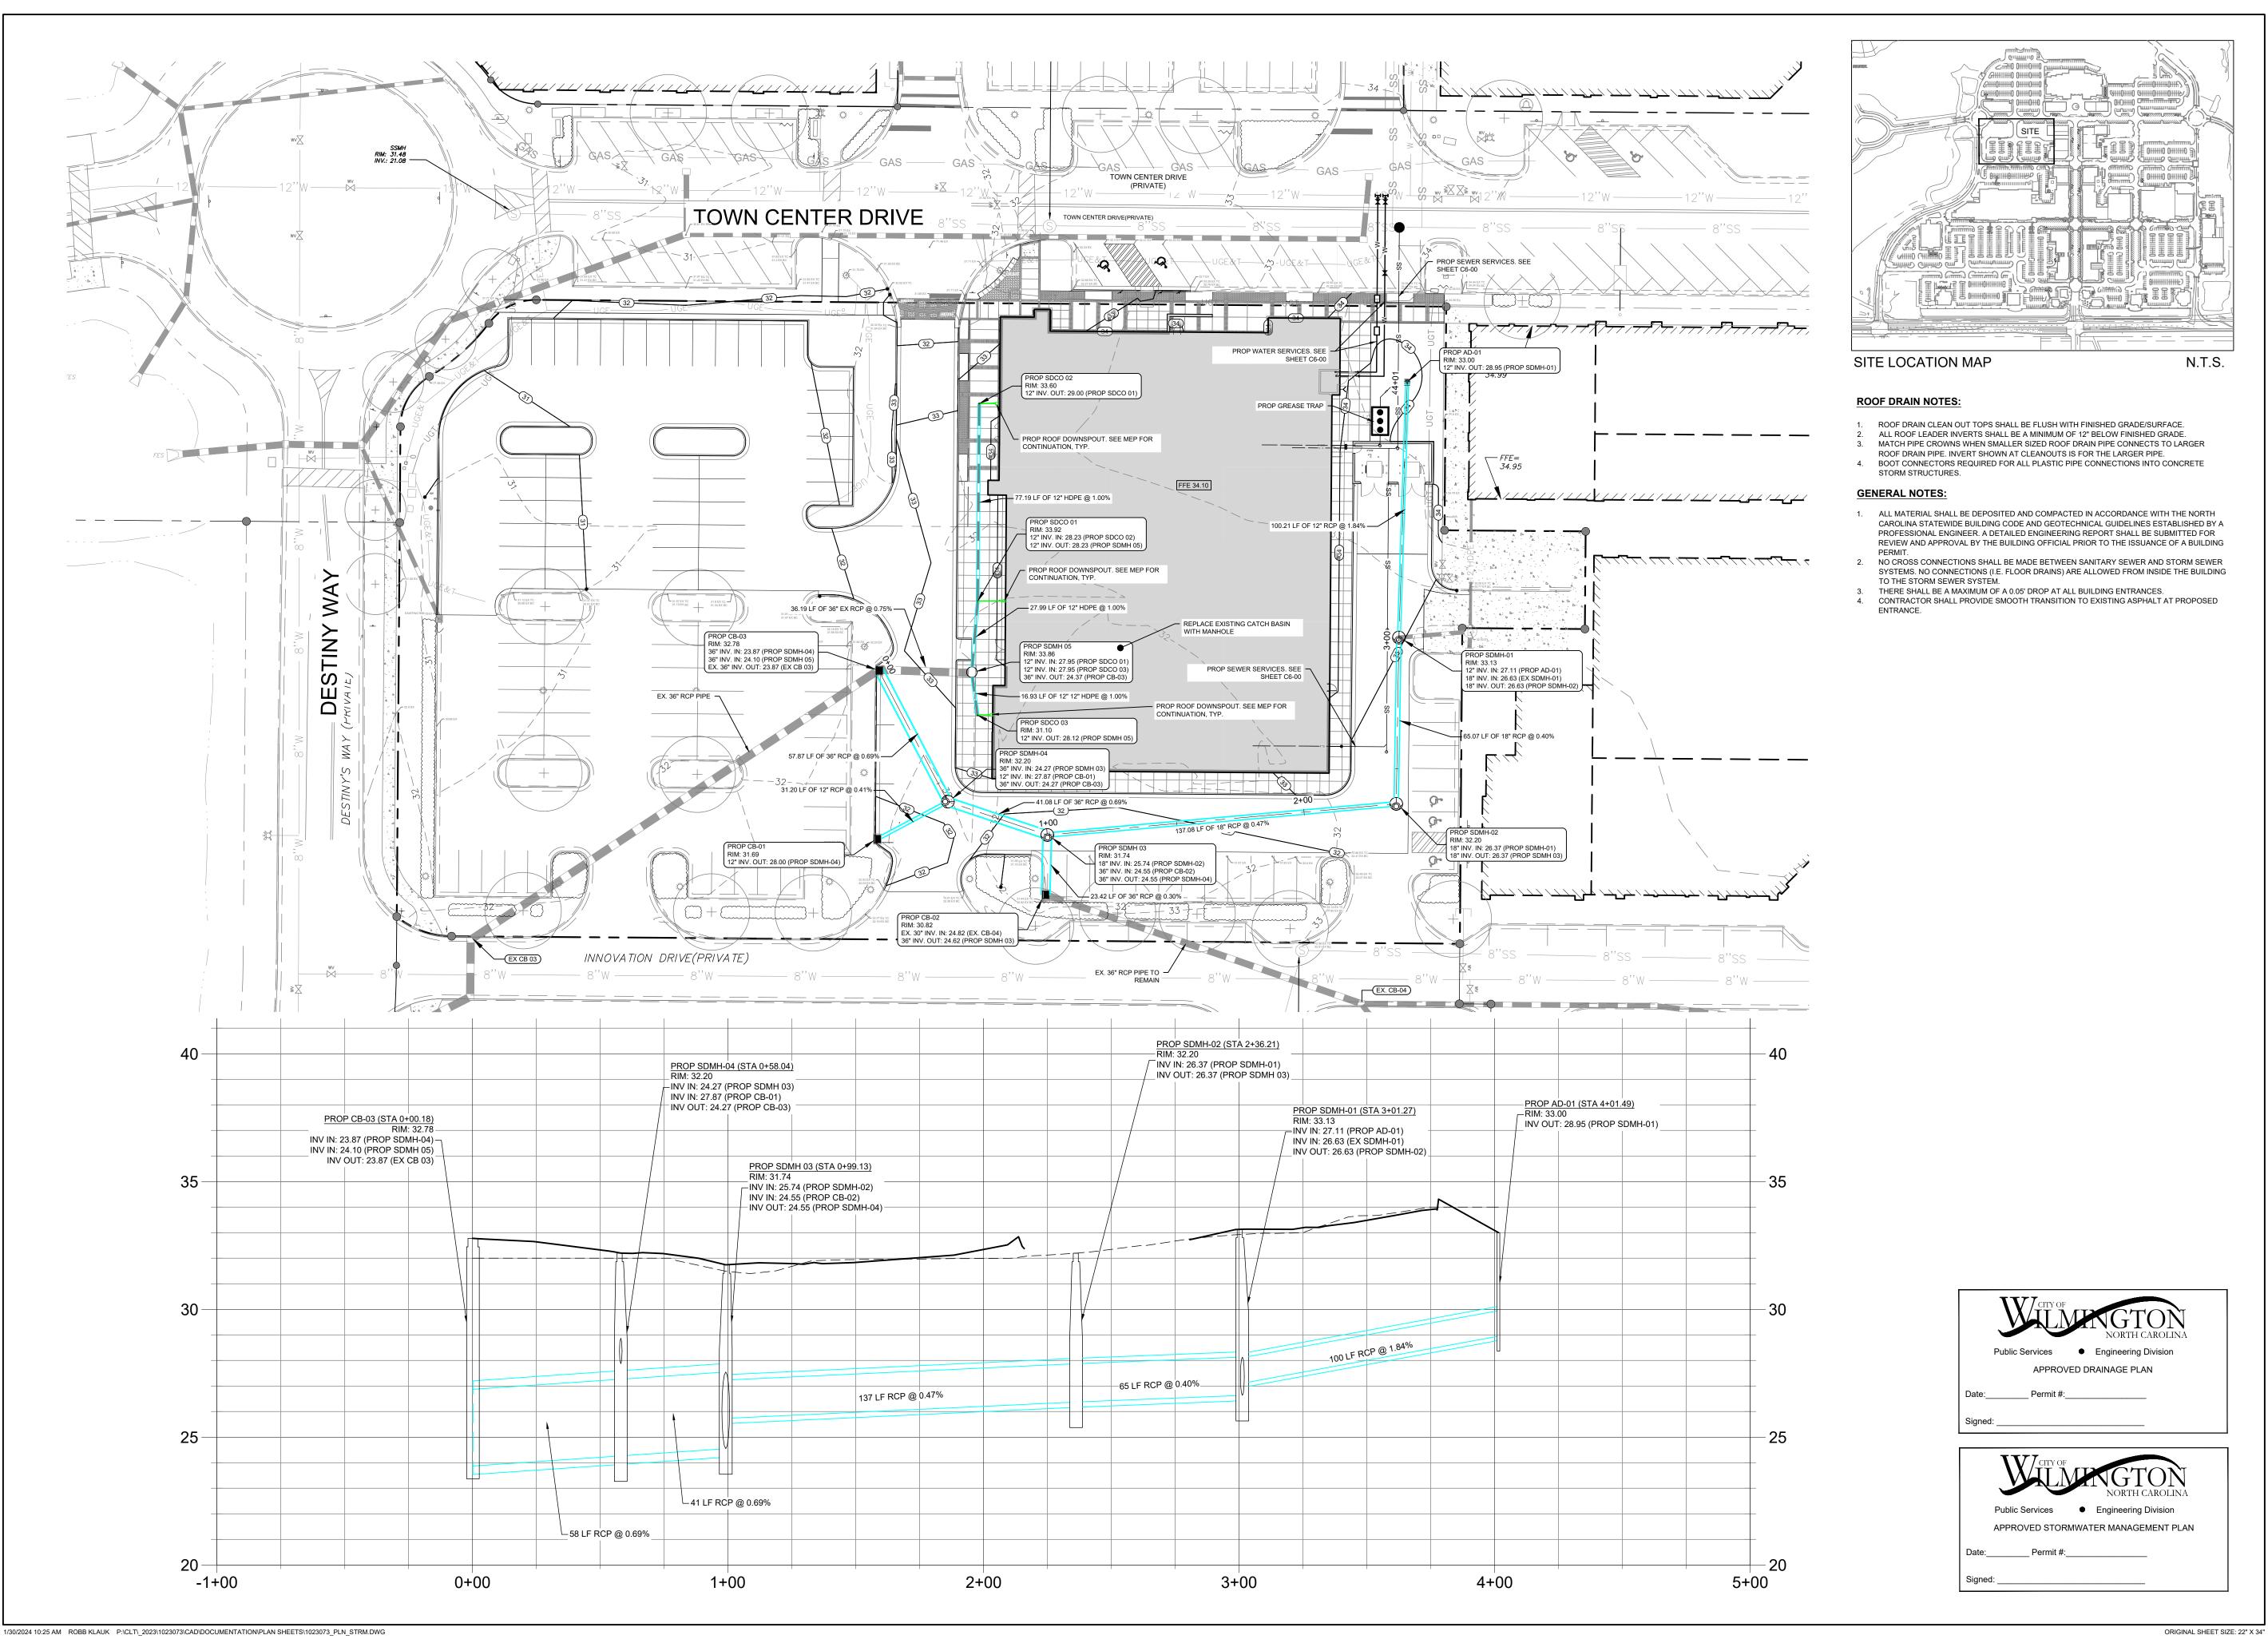
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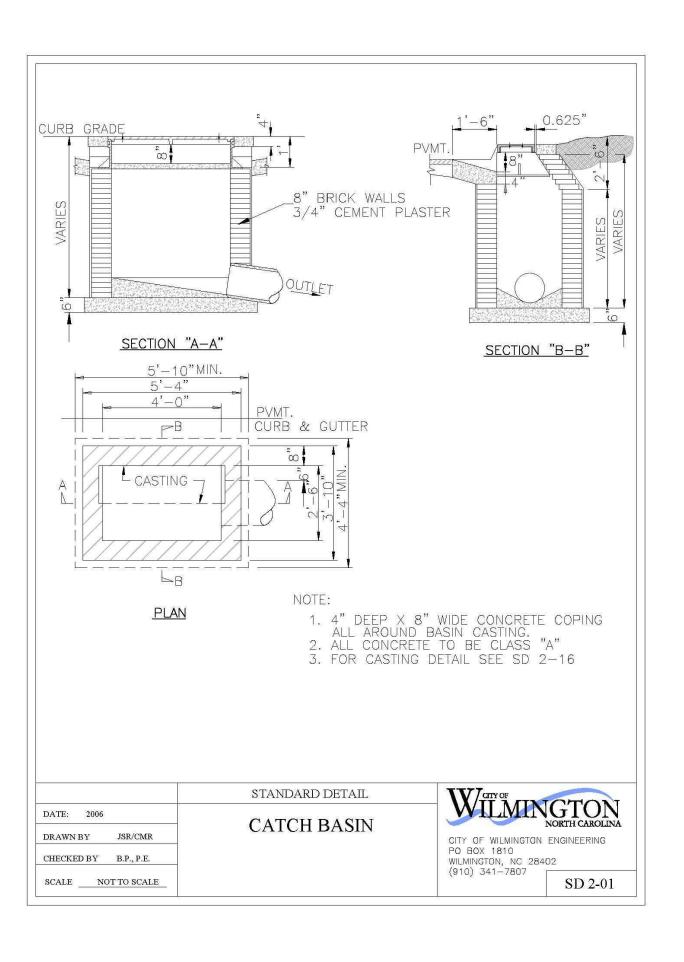
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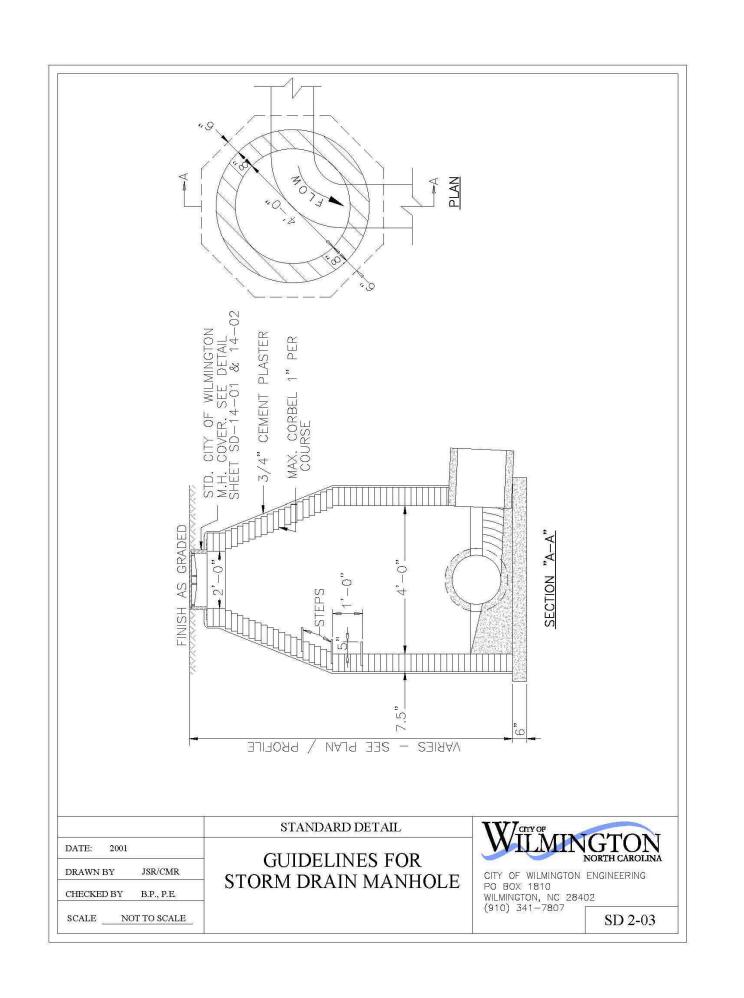
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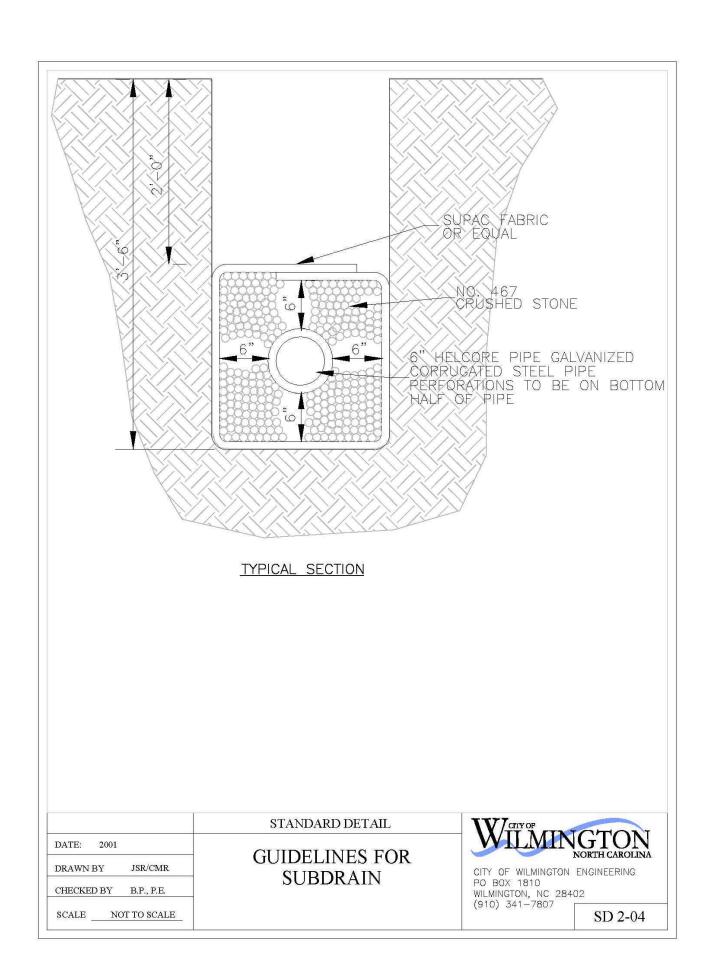
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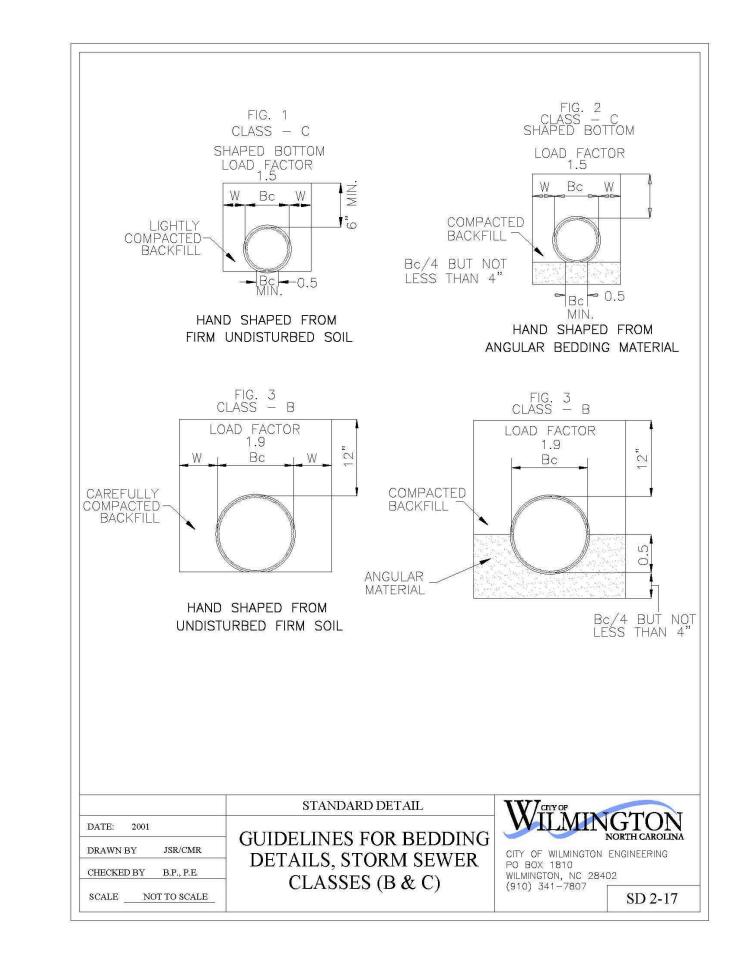
STORM DRAINAGE PLAN

C5-01











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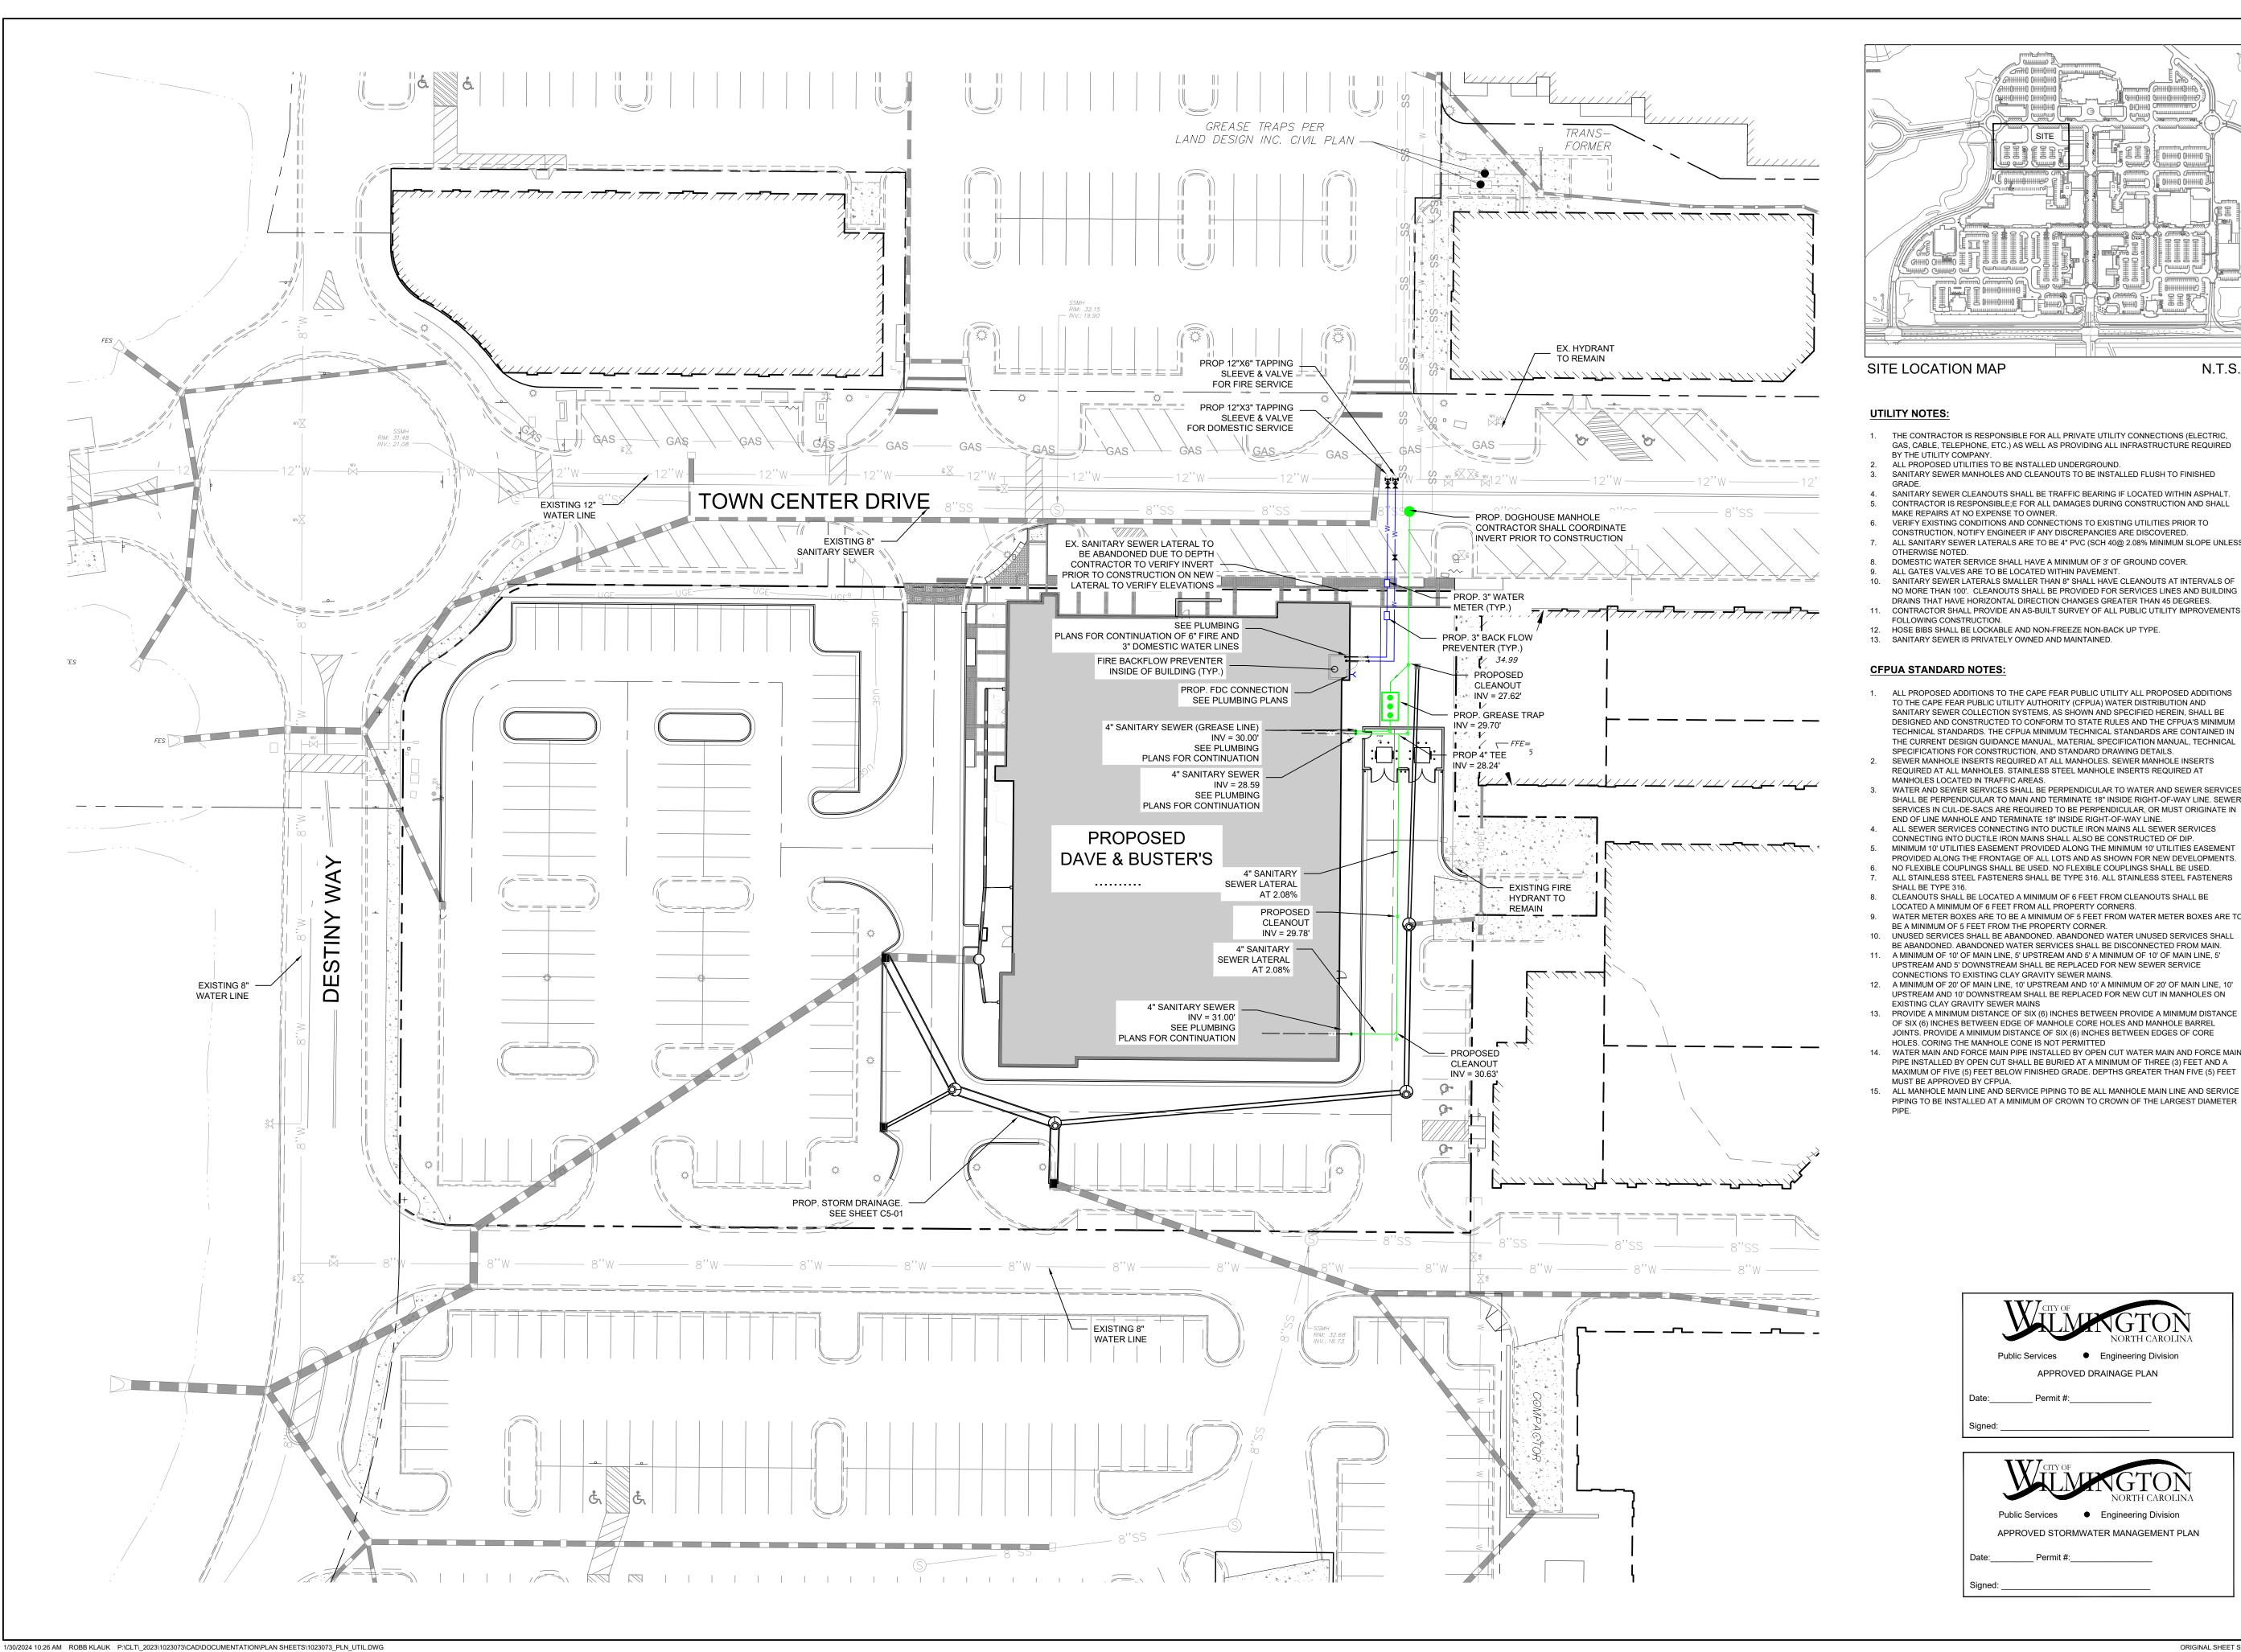
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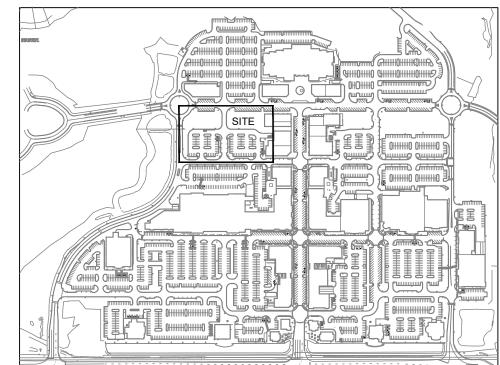
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STORM DRAINAGE DETAILS

C5-02

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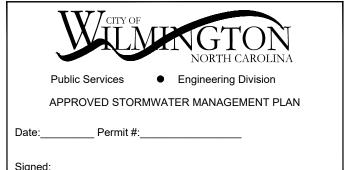
SITE LOCATION MAP

N.T.S.

- 1. THE CONTRACTOR IS RESPONSIBLE FOR ALL PRIVATE UTILITY CONNECTIONS (ELECTRIC, GAS, CABLE, TELEPHONE, ETC.) AS WELL AS PROVIDING ALL INFRASTRUCTURE REQUIRED
- ALL PROPOSED UTILITIES TO BE INSTALLED UNDERGROUND.
- SANITARY SEWER MANHOLES AND CLEANOUTS TO BE INSTALLED FLUSH TO FINISHED
- CONTRACTOR IS RESPONSIBLE;E FOR ALL DAMAGES DURING CONSTRUCTION AND SHALL MAKE REPAIRS AT NO EXPENSE TO OWNER.
- 6. VERIFY EXISTING CONDITIONS AND CONNECTIONS TO EXISTING UTILITIES PRIOR TO CONSTRUCTION, NOTIFY ENGINEER IF ANY DISCREPANCIES ARE DISCOVERED.
- 7. ALL SANITARY SEWER LATERALS ARE TO BE 4" PVC (SCH 40@ 2.08% MINIMUM SLOPE UNLESS OTHERWISE NOTED.
- DOMESTIC WATER SERVICE SHALL HAVE A MINIMUM OF 3' OF GROUND COVER. ALL GATES VALVES ARE TO BE LOCATED WITHIN PAVEMENT.
- SANITARY SEWER LATERALS SMALLER THAN 8" SHALL HAVE CLEANOUTS AT INTERVALS OF NO MORE THAN 100'. CLEANOUTS SHALL BE PROVIDED FOR SERVICES LINES AND BUILDING
- DRAINS THAT HAVE HORIZONTAL DIRECTION CHANGES GREATER THAN 45 DEGREES. CONTRACTOR SHALL PROVIDE AN AS-BUILT SURVEY OF ALL PUBLIC UTILITY IMPROVEMENTS FOLLOWING CONSTRUCTION.
- HOSE BIBS SHALL BE LOCKABLE AND NON-FREEZE NON-BACK UP TYPE.

- 1. ALL PROPOSED ADDITIONS TO THE CAPE FEAR PUBLIC UTILITY ALL PROPOSED ADDITIONS TO THE CAPE FEAR PUBLIC UTILITY AUTHORITY (CFPUA) WATER DISTRIBUTION AND SANITARY SEWER COLLECTION SYSTEMS, AS SHOWN AND SPECIFIED HEREIN, SHALL BE DESIGNED AND CONSTRUCTED TO CONFORM TO STATE RULES AND THE CFPUA'S MINIMUM TECHNICAL STANDARDS, THE CFPUA MINIMUM TECHNICAL STANDARDS ARE CONTAINED IN THE CURRENT DESIGN GUIDANCE MANUAL, MATERIAL SPECIFICATION MANUAL, TECHNICAL
- SPECIFICATIONS FOR CONSTRUCTION, AND STANDARD DRAWING DETAILS. 2. SEWER MANHOLE INSERTS REQUIRED AT ALL MANHOLES. SEWER MANHOLE INSERTS REQUIRED AT ALL MANHOLES. STAINLESS STEEL MANHOLE INSERTS REQUIRED AT MANHOLES LOCATED IN TRAFFIC AREAS.
- WATER AND SEWER SERVICES SHALL BE PERPENDICULAR TO WATER AND SEWER SERVICES SHALL BE PERPENDICULAR TO MAIN AND TERMINATE 18" INSIDE RIGHT-OF-WAY LINE. SEWER SERVICES IN CUL-DE-SACS ARE REQUIRED TO BE PERPENDICULAR, OR MUST ORIGINATE IN END OF LINE MANHOLE AND TERMINATE 18" INSIDE RIGHT-OF-WAY LINE.
- ALL SEWER SERVICES CONNECTING INTO DUCTILE IRON MAINS ALL SEWER SERVICES CONNECTING INTO DUCTILE IRON MAINS SHALL ALSO BE CONSTRUCTED OF DIP. MINIMUM 10' UTILITIES EASEMENT PROVIDED ALONG THE MINIMUM 10' UTILITIES EASEMENT
- PROVIDED ALONG THE FRONTAGE OF ALL LOTS AND AS SHOWN FOR NEW DEVELOPMENTS. NO FLEXIBLE COUPLINGS SHALL BE USED. NO FLEXIBLE COUPLINGS SHALL BE USED.
- ALL STAINLESS STEEL FASTENERS SHALL BE TYPE 316. ALL STAINLESS STEEL FASTENERS SHALL BE TYPE 316.
- CLEANOUTS SHALL BE LOCATED A MINIMUM OF 6 FEET FROM CLEANOUTS SHALL BE LOCATED A MINIMUM OF 6 FEET FROM ALL PROPERTY CORNERS.
- 9. WATER METER BOXES ARE TO BE A MINIMUM OF 5 FEET FROM WATER METER BOXES ARE TO BE A MINIMUM OF 5 FEET FROM THE PROPERTY CORNER. 10. UNUSED SERVICES SHALL BE ABANDONED. ABANDONED WATER UNUSED SERVICES SHALL
- BE ABANDONED. ABANDONED WATER SERVICES SHALL BE DISCONNECTED FROM MAI 11. A MINIMUM OF 10' OF MAIN LINE, 5' UPSTREAM AND 5' A MINIMUM OF 10' OF MAIN LINE, 5'
- UPSTREAM AND 5' DOWNSTREAM SHALL BE REPLACED FOR NEW SEWER SERVICE CONNECTIONS TO EXISTING CLAY GRAVITY SEWER MAINS. 12. A MINIMUM OF 20' OF MAIN LINE, 10' UPSTREAM AND 10' A MINIMUM OF 20' OF MAIN LINE, 10'
- UPSTREAM AND 10' DOWNSTREAM SHALL BE REPLACED FOR NEW CUT IN MANHOLES ON EXISTING CLAY GRAVITY SEWER MAINS 13. PROVIDE A MINIMUM DISTANCE OF SIX (6) INCHES BETWEEN PROVIDE A MINIMUM DISTANCE
- OF SIX (6) INCHES BETWEEN EDGE OF MANHOLE CORE HOLES AND MANHOLE BARREL JOINTS. PROVIDE A MINIMUM DISTANCE OF SIX (6) INCHES BETWEEN EDGES OF CORE HOLES. CORING THE MANHOLE CONE IS NOT PERMITTED 14. WATER MAIN AND FORCE MAIN PIPE INSTALLED BY OPEN CUT WATER MAIN AND FORCE MAIN
- PIPE INSTALLED BY OPEN CUT SHALL BE BURIED AT A MINIMUM OF THREE (3) FEET AND A MAXIMUM OF FIVE (5) FEET BELOW FINISHED GRADE. DEPTHS GREATER THAN FIVE (5) FEET MUST BE APPROVED BY CFPUA. 15. ALL MANHOLE MAIN LINE AND SERVICE PIPING TO BE ALL MANHOLE MAIN LINE AND SERVICE





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DAVE & BUSTER'S - MAYFAIRE

MAYFAIRE TOWN CENTER

WILMINGTON, NC


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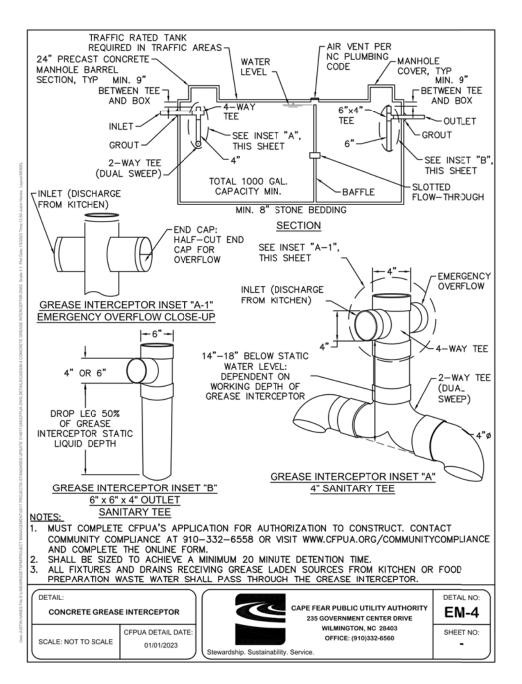
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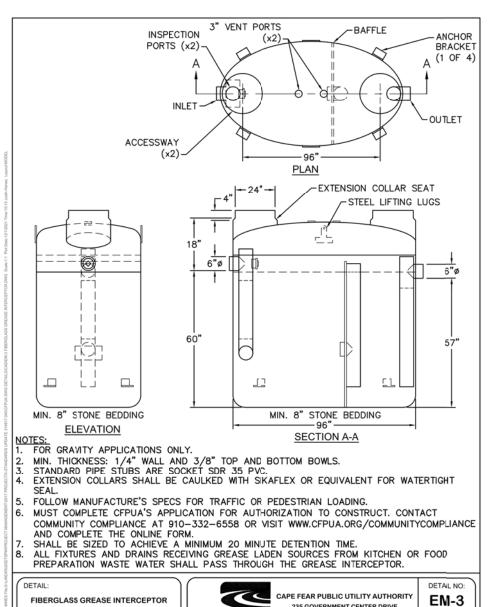
ORIGINAL SHEET SIZE: 22" X 34"

OVERALL UTILITY PLAN

C6-00





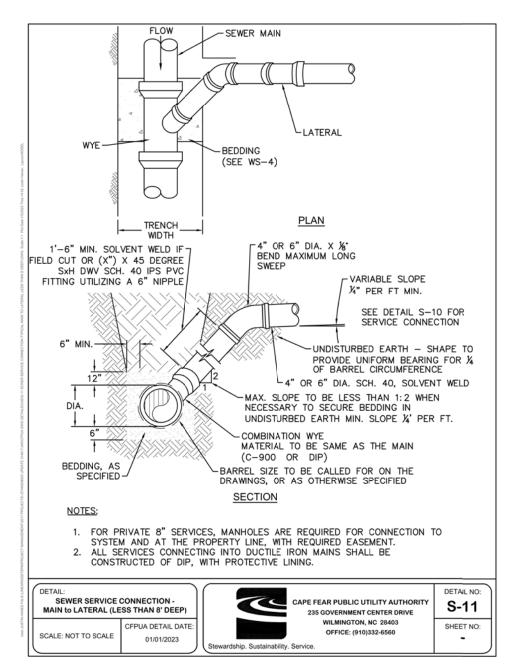

235 GOVERNMENT CENTER DRIVE

FINAL GRADE

WILMINGTON, NC 28403

FIBERGLASS GREASE INTERCEPTOR

SCALE: NOT TO SCALE

CFPUA DETAIL DATE

01/01/2023

FINAL GRADE

01/01/2023

LID FLUSH W/ FINISHED GRADE-

AS REQUIRED -

PAVEMENT REPAIR

VALVE DETAIL

CFPUA DETAIL DATE

PAVED AREA

1. TRACER WIRE SHALL PENETRATE VALVE BOX THROUGH DRILLED

LENGTH COILED IN THE VALVE BOX. SEE WS-6.

HOLE APPROX. 6" BELOW GRADE WITH MINIMUM 2-FEET EXTRA

UNPAVED AREA

-PRECAST CONCRETE COLLAR

LINE ON COLLAR

VALVE BOX W/LID

DETECTION TAPE -TRACER WIRE


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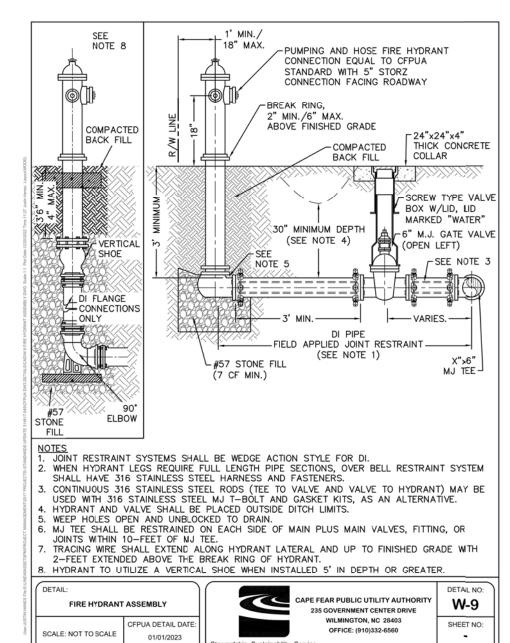
CAPE FEAR PUBLIC UTILITY AUTHORITY


WILMINGTON, NC 28403

►M.J. GATE VALVE


FINISH GRADE TO REVEAL




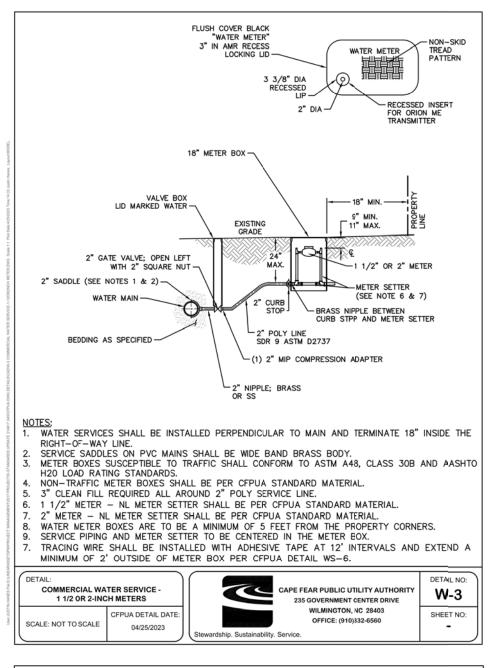


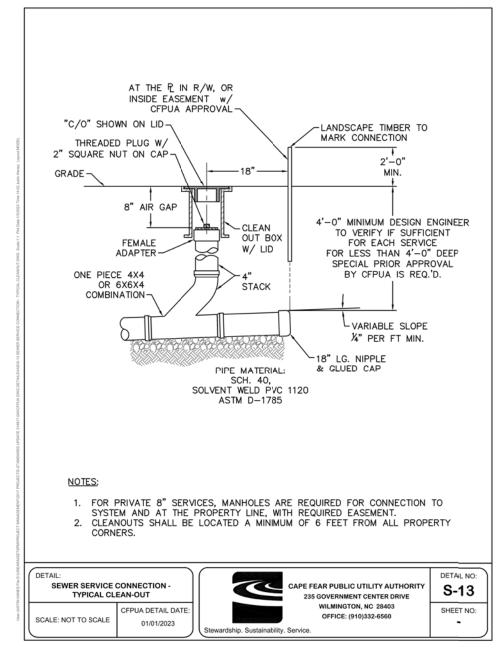



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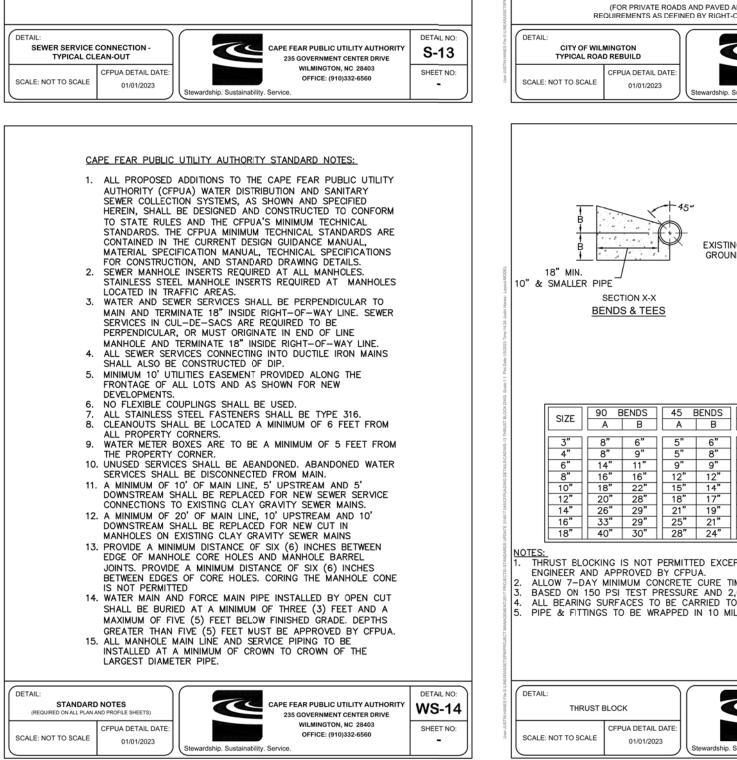


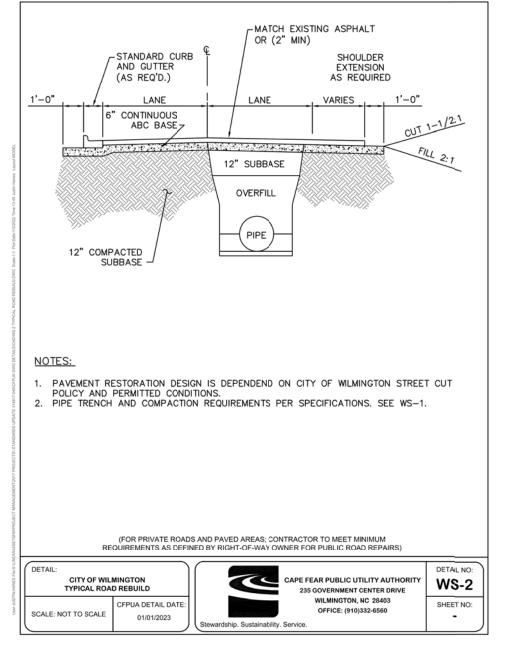


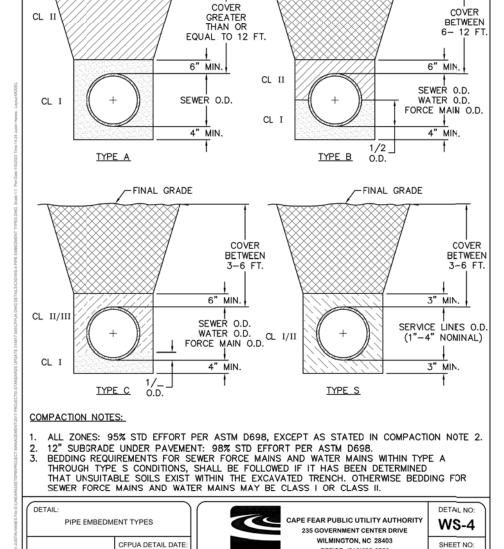


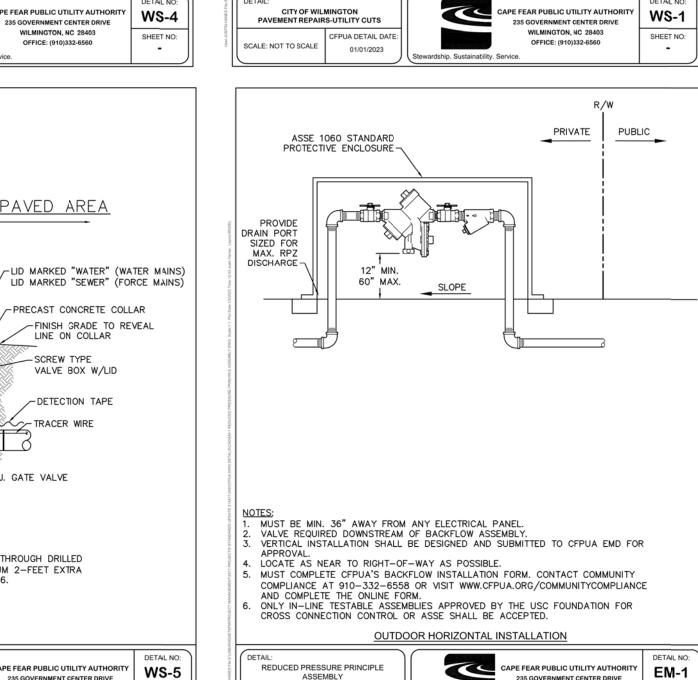


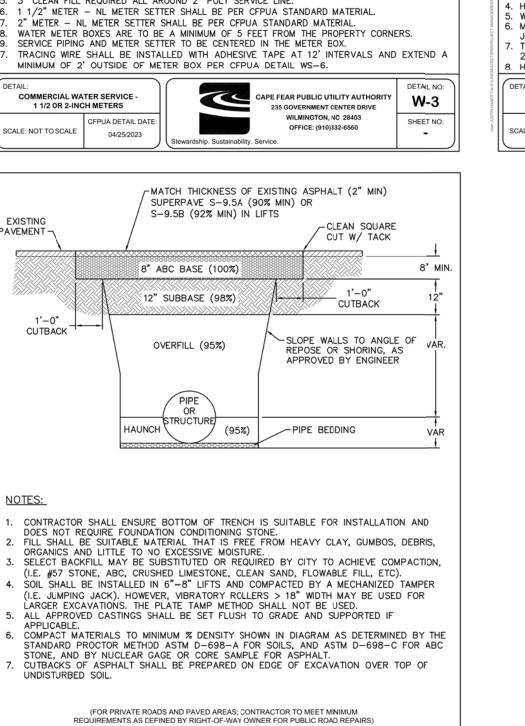

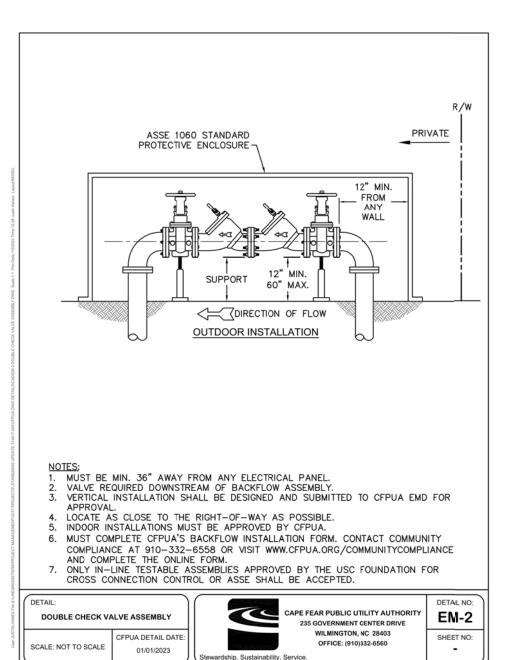

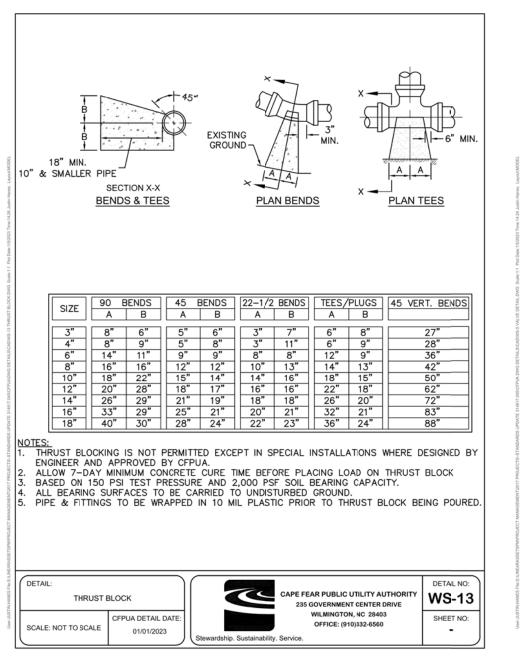

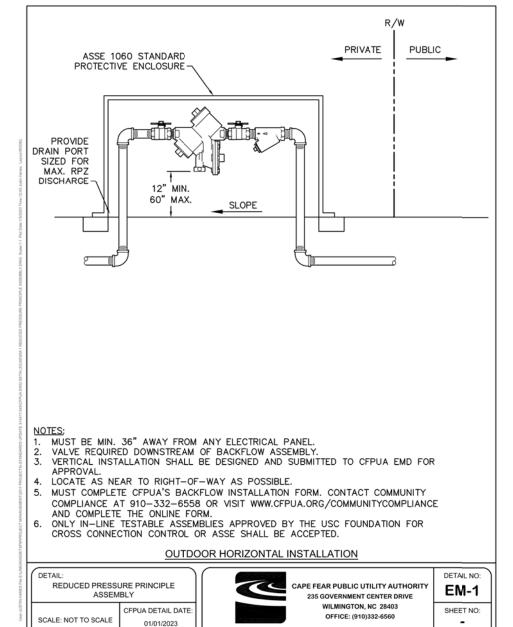

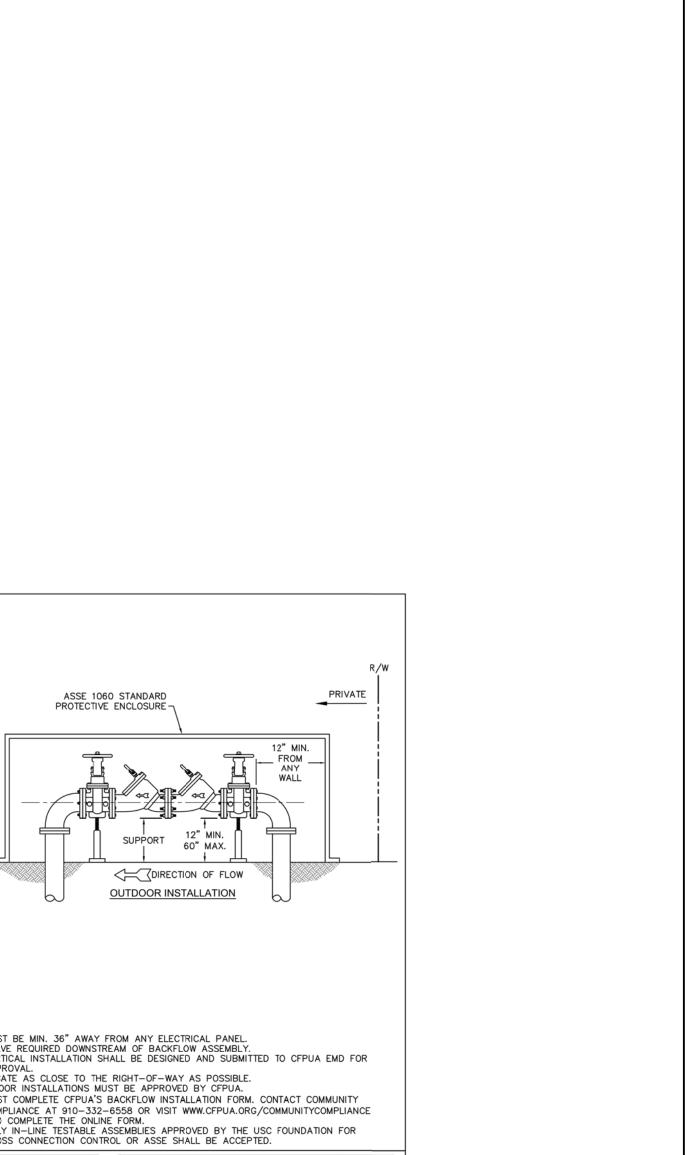

ORIGINAL SHEET SIZE: 22" X 34"

223 NORTH GRAHAM STREET

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Alyssa M. Moniaci 046144 1/29/2024 REG.#

DAVE & BUSTER'S - MAYFAIRE

MAYFAIRE TOWN CENTER


WILMINGTON, NC

1023073 REVISION / ISSUANCE NO. DESCRIPTION DATE DESIGNED BY: RJK DRAWN BY: RJK CHECKED BY: RJK


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UTILITY DETAILS



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SITE LOCATION MAP

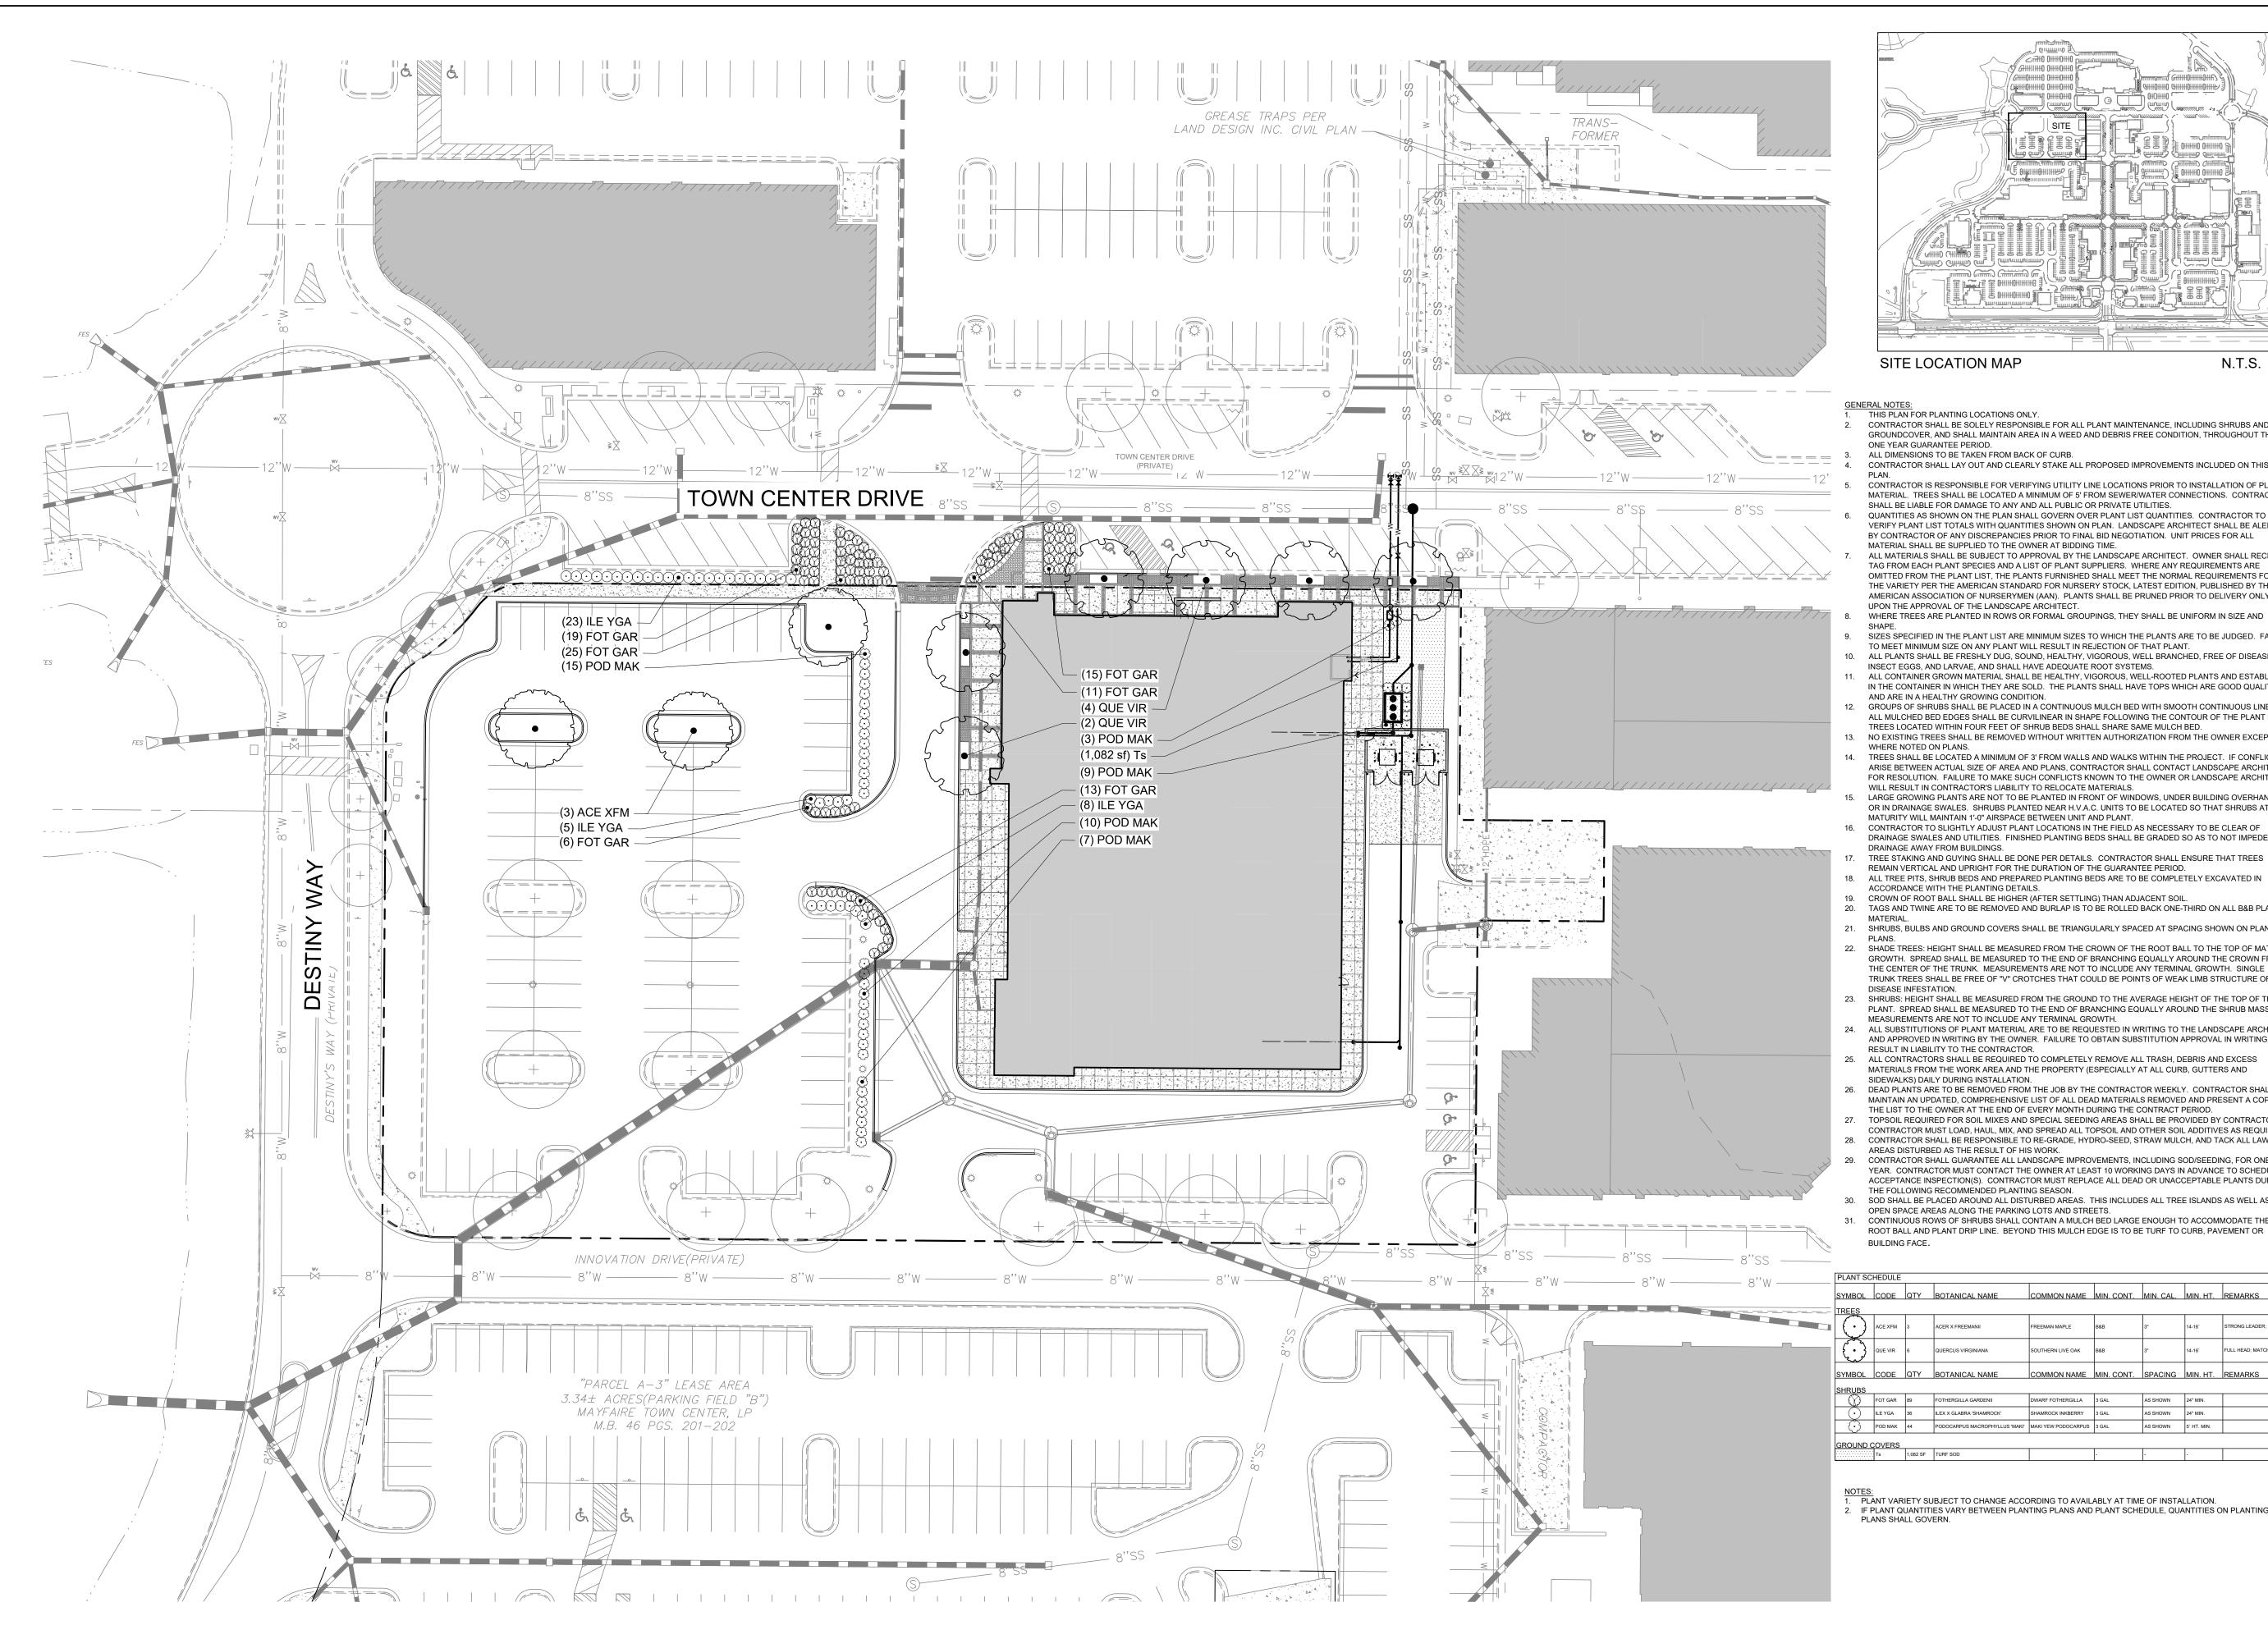N.T.S.

GENERAL NOTES:

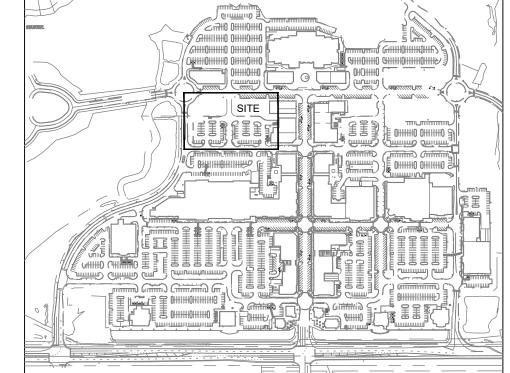1. THIS PLAN FOR PLANTING LOCATIONS ONLY.

CONTRACTOR SHALL BE SOLELY RESPONSIBLE FOR ALL PLANT MAINTENANCE, INCLUDING SHRUBS AND GROUNDCOVER, AND SHALL MAINTAIN AREA IN A WEED AND DEBRIS FREE CONDITION, THROUGHOUT THE ONE YEAR GUARANTEE PERIOD.

ALL DIMENSIONS TO BE TAKEN FROM BACK OF CURB. CONTRACTOR SHALL LAY OUT AND CLEARLY STAKE ALL PROPOSED IMPROVEMENTS INCLUDED ON THIS

CONTRACTOR IS RESPONSIBLE FOR VERIFYING UTILITY LINE LOCATIONS PRIOR TO INSTALLATION OF PLANT MATERIAL. TREES SHALL BE LOCATED A MINIMUM OF 5' FROM SEWER/WATER CONNECTIONS. CONTRACTOR SHALL BE LIABLE FOR DAMAGE TO ANY AND ALL PUBLIC OR PRIVATE UTILITIES.

VERIFY PLANT LIST TOTALS WITH QUANTITIES SHOWN ON PLAN. LANDSCAPE ARCHITECT SHALL BE ALERTED BY CONTRACTOR OF ANY DISCREPANCIES PRIOR TO FINAL BID NEGOTIATION. UNIT PRICES FOR ALL MATERIAL SHALL BE SUPPLIED TO THE OWNER AT BIDDING TIME. ALL MATERIALS SHALL BE SUBJECT TO APPROVAL BY THE LANDSCAPE ARCHITECT. OWNER SHALL RECEIVE

FAG FROM EACH PLANT SPECIES AND A LIST OF PLANT SUPPLIERS. WHERE ANY REQUIREMENTS ARE OMITTED FROM THE PLANT LIST THE PLANTS FURNISHED SHALL MEET THE NORMAL REQUIREMENTS FOR THE VARIETY PER THE AMERICAN STANDARD FOR NURSERY STOCK, LATEST EDITION, PUBLISHED BY THE AMERICAN ASSOCIATION OF NURSERYMEN (AAN). PLANTS SHALL BE PRUNED PRIOR TO DELIVERY ONLY UPON THE APPROVAL OF THE LANDSCAPE ARCHITECT.

WHERE TREES ARE PLANTED IN ROWS OR FORMAL GROUPINGS, THEY SHALL BE UNIFORM IN SIZE AND

SIZES SPECIFIED IN THE PLANT LIST ARE MINIMUM SIZES TO WHICH THE PLANTS ARE TO BE JUDGED. FAILURE TO MEET MINIMUM SIZE ON ANY PLANT WILL RESULT IN REJECTION OF THAT PLANT.

ALL PLANTS SHALL BE FRESHLY DUG, SOUND, HEALTHY, VIGOROUS, WELL BRANCHED, FREE OF DISEASE, INSECT EGGS, AND LARVAE, AND SHALL HAVE ADEQUATE ROOT SYSTEMS. ALL CONTAINER GROWN MATERIAL SHALL BE HEALTHY, VIGOROUS, WELL-ROOTED PLANTS AND ESTABLISHED

IN THE CONTAINER IN WHICH THEY ARE SOLD. THE PLANTS SHALL HAVE TOPS WHICH ARE GOOD QUALITY AND ARE IN A HEALTHY GROWING CONDITION. 12. GROUPS OF SHRUBS SHALL BE PLACED IN A CONTINUOUS MULCH BED WITH SMOOTH CONTINUOUS LINES.

ALL MULCHED BED EDGES SHALL BE CURVILINEAR IN SHAPE FOLLOWING THE CONTOUR OF THE PLANT MASS. TREES LOCATED WITHIN FOUR FEET OF SHRUB BEDS SHALL SHARE SAME MULCH BED.

NO EXISTING TREES SHALL BE REMOVED WITHOUT WRITTEN AUTHORIZATION FROM THE OWNER EXCEPT WHERE NOTED ON PLANS TREES SHALL BE LOCATED A MINIMUM OF 3' FROM WALLS AND WALKS WITHIN THE PROJECT. IF CONFLICTS ARISE BETWEEN ACTUAL SIZE OF AREA AND PLANS, CONTRACTOR SHALL CONTACT LANDSCAPE ARCHITECT FOR RESOLUTION. FAILURE TO MAKE SUCH CONFLICTS KNOWN TO THE OWNER OR LANDSCAPE ARCHITECT

WILL RESULT IN CONTRACTOR'S LIABILITY TO RELOCATE MATERIALS. 15. LARGE GROWING PLANTS ARE NOT TO BE PLANTED IN FRONT OF WINDOWS, UNDER BUILDING OVERHANGS, OR IN DRAINAGE SWALES. SHRUBS PLANTED NEAR H.V.A.C. UNITS TO BE LOCATED SO THAT SHRUBS AT

MATURITY WILL MAINTAIN 1'-0" AIRSPACE BETWEEN UNIT AND PLANT. 16. CONTRACTOR TO SLIGHTLY ADJUST PLANT LOCATIONS IN THE FIELD AS NECESSARY TO BE CLEAR OF DRAINAGE SWALES AND UTILITIES. FINISHED PLANTING BEDS SHALL BE GRADED SO AS TO NOT IMPEDE

DRAINAGE AWAY FROM BUILDINGS. TREE STAKING AND GUYING SHALL BE DONE PER DETAILS. CONTRACTOR SHALL ENSURE THAT TREES REMAIN VERTICAL AND UPRIGHT FOR THE DURATION OF THE GUARANTEE PERIOD.

18. ALL TREE PITS, SHRUB BEDS AND PREPARED PLANTING BEDS ARE TO BE COMPLETELY EXCAVATED IN ACCORDANCE WITH THE PLANTING DETAILS.

CROWN OF ROOT BALL SHALL BE HIGHER (AFTER SETTLING) THAN ADJACENT SOIL. TAGS AND TWINE ARE TO BE REMOVED AND BURLAP IS TO BE ROLLED BACK ONE-THIRD ON ALL B&B PLANT

21. SHRUBS, BULBS AND GROUND COVERS SHALL BE TRIANGULARLY SPACED AT SPACING SHOWN ON PLANTING

GROWTH. SPREAD SHALL BE MEASURED TO THE END OF BRANCHING EQUALLY AROUND THE CROWN FROM

THE CENTER OF THE TRUNK. MEASUREMENTS ARE NOT TO INCLUDE ANY TERMINAL GROWTH. SINGLE TRUNK TREES SHALL BE FREE OF "V" CROTCHES THAT COULD BE POINTS OF WEAK LIMB STRUCTURE OR DISEASE INFESTATION. 23. SHRUBS: HEIGHT SHALL BE MEASURED FROM THE GROUND TO THE AVERAGE HEIGHT OF THE TOP OF THE

PLANT. SPREAD SHALL BE MEASURED TO THE END OF BRANCHING EQUALLY AROUND THE SHRUB MASS. MEASUREMENTS ARE NOT TO INCLUDE ANY TERMINAL GROWTH.

ALL SUBSTITUTIONS OF PLANT MATERIAL ARE TO BE REQUESTED IN WRITING TO THE LANDSCAPE ARCHITECT AND APPROVED IN WRITING BY THE OWNER. FAILURE TO OBTAIN SUBSTITUTION APPROVAL IN WRITING MAY RESULT IN LIABILITY TO THE CONTRACTOR. 25. ALL CONTRACTORS SHALL BE REQUIRED TO COMPLETELY REMOVE ALL TRASH, DEBRIS AND EXCESS

SIDEWALKS) DAILY DURING INSTALLATION. 26. DEAD PLANTS ARE TO BE REMOVED FROM THE JOB BY THE CONTRACTOR WEEKLY. CONTRACTOR SHALL MAINTAIN AN UPDATED, COMPREHENSIVE LIST OF ALL DEAD MATERIALS REMOVED AND PRESENT A COPY OF

THE LIST TO THE OWNER AT THE END OF EVERY MONTH DURING THE CONTRACT PERIOD. 27. TOPSOIL REQUIRED FOR SOIL MIXES AND SPECIAL SEEDING AREAS SHALL BE PROVIDED BY CONTRACTOR. CONTRACTOR MUST LOAD, HAUL, MIX, AND SPREAD ALL TOPSOIL AND OTHER SOIL ADDITIVES AS REQUIRED.

28. CONTRACTOR SHALL BE RESPONSIBLE TO RE-GRADE, HYDRO-SEED, STRAW MULCH, AND TACK ALL LAWN AREAS DISTURBED AS THE RESULT OF HIS WORK. CONTRACTOR SHALL GUARANTEE ALL LANDSCAPE IMPROVEMENTS, INCLUDING SOD/SEEDING, FOR ONE FULL YEAR. CONTRACTOR MUST CONTACT THE OWNER AT LEAST 10 WORKING DAYS IN ADVANCE TO SCHEDULE ACCEPTANCE INSPECTION(S). CONTRACTOR MUST REPLACE ALL DEAD OR UNACCEPTABLE PLANTS DURING

THE FOLLOWING RECOMMENDED PLANTING SEASON. 30. SOD SHALL BE PLACED AROUND ALL DISTURBED AREAS. THIS INCLUDES ALL TREE ISLANDS AS WELL AS OPEN SPACE AREAS ALONG THE PARKING LOTS AND STREETS.

31. CONTINUOUS ROWS OF SHRUBS SHALL CONTAIN A MULCH BED LARGE ENOUGH TO ACCOMMODATE THE ROOT BALL AND PLANT DRIP LINE. BEYOND THIS MULCH EDGE IS TO BE TURF TO CURB, PAVEMENT OR BUILDING FACE.

_	PLANT SC	HEDULE							
	SYMBOL	CODE	QTY	BOTANICAL NAME	COMMON NAME	MIN. CONT.	MIN. CAL.	MIN. HT.	REMARKS
=	TREES								
1	\odot	ACE XFM	3	ACER X FREEMANII	FREEMAN MAPLE	B&B	3"	14-16`	STRONG LEADER; MATCHING.
		QUE VIR	6	QUERCUS VIRGINIANA	SOUTHERN LIVE OAK	B&B	3"	14-16`	FULL HEAD; MATCHING.
	SYMBOL	CODE	QTY	BOTANICAL NAME	COMMON NAME	MIN. CONT.	SPACING	MIN. HT.	REMARKS
	SHRUBS								
		FOT GAR	89	FOTHERGILLA GARDENII	DWARF FOTHERGILLA	3 GAL	AS SHOWN	24" MIN.	
	\odot	ILE YGA	36	ILEX X GLABRA 'SHAMROCK'	SHAMROCK INKBERRY	3 GAL	AS SHOWN	24" MIN.	
	\bigcirc	POD MAK	44	PODOCARPUS MACROPHYLLUS 'MAKI'	MAKI YEW PODOCARPUS	3 GAL	AS SHOWN	5` HT. MIN.	

NOTES:

1. PLANT VARIETY SUBJECT TO CHANGE ACCORDING TO AVAILABLY AT TIME OF INSTALLATION. 2. IF PLANT QUANTITIES VARY BETWEEN PLANTING PLANS AND PLANT SCHEDULE, QUANTITIES ON PLANTING

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- MAYFAIRE

MAYFAIRE TOWN CENTER WILMINGTON, NC


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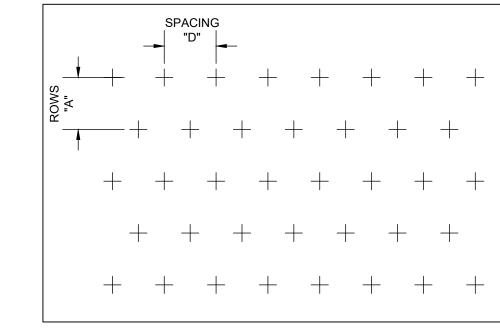
DESIGNED BY: RJK DRAWN BY: RJK CHECKED BY: RJK

ORIGINAL SHEET SIZE: 22" X 34"

OVERALL PLANTING PLAN

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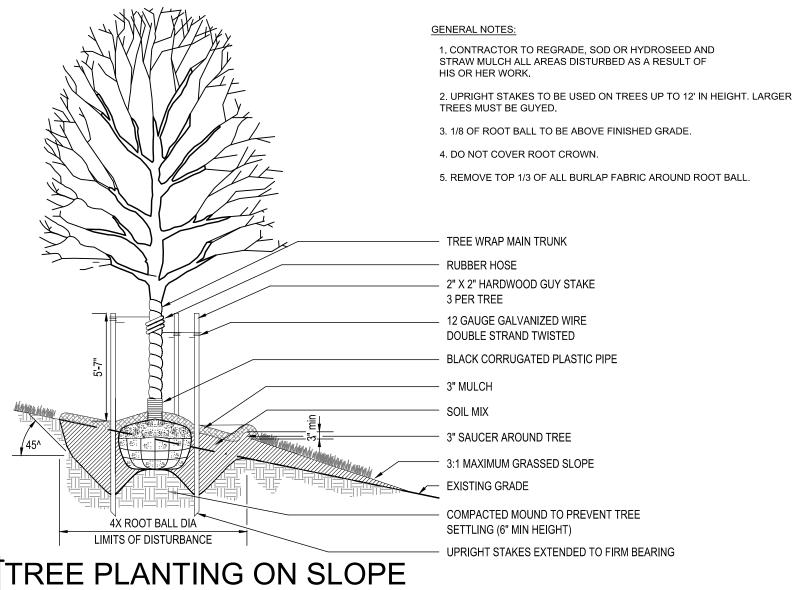


	PLANT SPACING CHART	
SPACING "D"	ROW "A"	PLANTS / S.F.
6" O.C. 8" O.C. 10" O.C. 12" O.C. 15" O.C. 18" O.C. 24" O.C.	5.20" O.C. 6.93" O.C. 8.66" O.C. 10.40" O.C. 13.00" O.C. 15.60" O.C. 20.80" O.C.	4.61 2.60 1.66 1.15 0.73 0.51 0.29

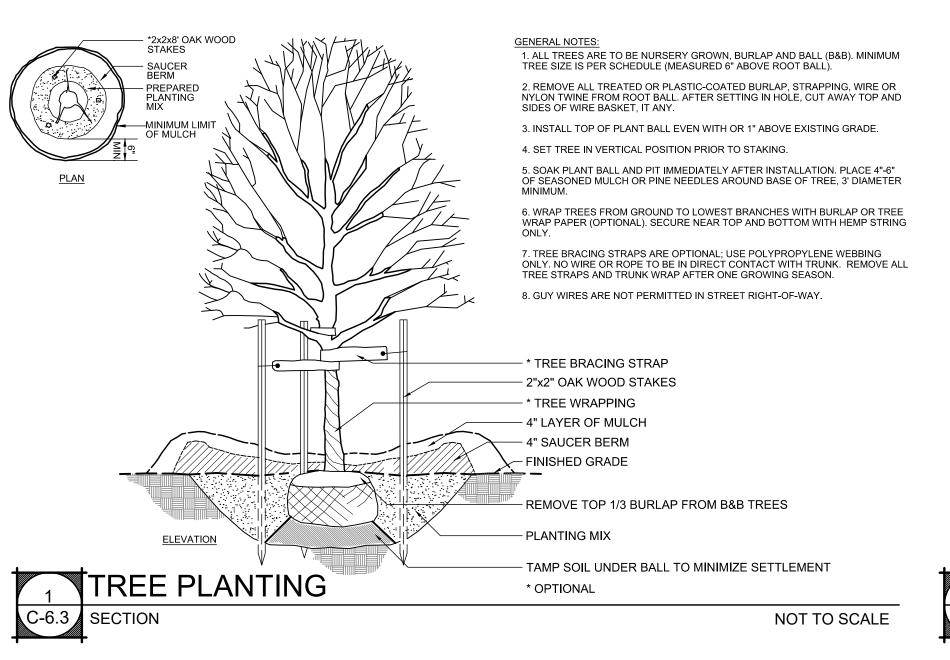

NOT TO SCALE

NTS



GENERAL NOTES:

EACH PLANT BALL.

- 4" LAYER OF MULCH

- COLLAR-MIN. 2" HT

- ADJACENT GRADE

INSTALLATION.

GRADE.

SYSTEM IS PRESENT.

1. OMIT COLLAR AROUND EACH SHRUB WHEN IRRIGATION

2. INSTALL TOP OF PLANT BALL 2" ABOVE ADJACENT

3. TAMP PLANTING MIX FIRMLY AS PIT IS FILLED AROUND

4. SOAK EACH PLANT BALL AND PIT IMMEDIATELY AFTER

"V" TRENCH AROUND ENTIRE PLANTING BED,

NOT TO SCALE

UNLESS OTHERWISE SPECIFIED


SOIL MIX UNDER EACH PLANT


PLANTING MIX AS SPECIFIED

BALL TO MINIMIZE SETTLEMENT TAMP

EDGE OF PLANTING BED

SEE PLANTING PLAN

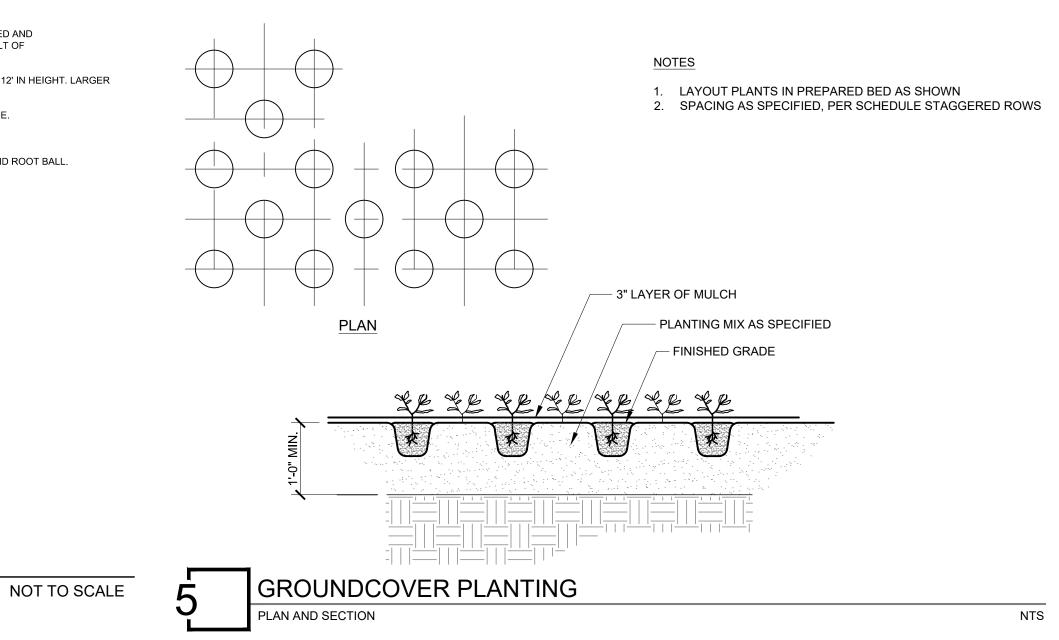

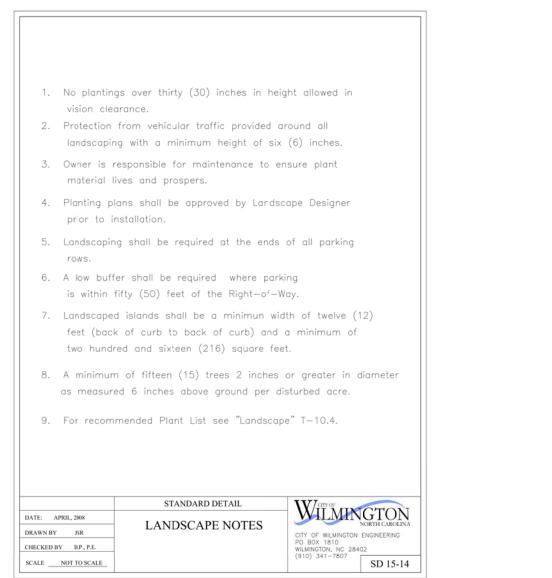


Public Services • Engineering Division

APPROVED DRAINAGE PLAN

Date:_____ Permit #:_____

Signed: _____

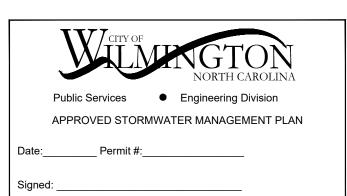

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3 SHRUB PLANTING
C-6.3 SECTION AND PLAN

TYPICAL PLANTING BED DETAIL

EQUAL SPACING

BETWEEN ALL PLANTS

TYP. STAGGARED ROWS

EDGE OF PLANTING

LANDSCAPE NOTES

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PLANTING DETAILS

C7-10